

#### Transmittal Page 1 of 2

To: Planning Department

**CC:** Justice Marks

City of Kelowna justice@handhhomes.ca

December 21, 2023

Re: Design Rationale for the Proposed Development of

2654 Gore Street, Kelowna, BC (The Site)

Dear City of Kelowna Planning Department,

Further to submitted information as it pertains to the Development Permit application associated with the proposed Development of 2654 Gore Street in Kelowna, we offer the following Rationale for the project:

Located on the middle block of Gore Street, which intersects with Osprey Avenue, with parkade access from a lane. Gore Street is located in the Pandosy Urban Centre of Kelowna. The development is located just outside the core area boundary, and is close to shopping, personal services, and restaurants allowing most errands from the location to be accomplished by foot. This property boasts a Bike Score of 91 and a Walk Score of 93, making the downtown core and surrounding community easily accessible. The Pandosy Urban Centre area is ideally located for multi-unit residential use as the area is experiencing tremendous growth while having the lowest number of residential units. Because of its associated high walk score and bike score, the reliance on automobile use is greatly reduced allowing the area to diversify while creating healthy community practices and reducing the residents carbon footprint.

The building design include portions of the building being stepped back, use of different colours and materials at intervals alongside the window pattern alternating. The lobby is located on the front corner of the building, with an entrance canopy providing definition. The building design includes easily accessible units with all units having access to short-term and long-term bicycle storage, with additional storage included. The reduction in automobile reliance in conjunction with the higher density infill development of the property contribute to a more sustainable approach to the building design that aligns with the City of Kelowna's Healthy City Strategy and planning initiatives.

The priority to densify precious, developable land within an existing core area while ensuring the neighbouring properties were respected resulted in a building that is under the 4-storey height allowance set out by the UC5 zoning. Achieving 7 residences on the property while being sensitive to the neighbourhood was felt to be important from a location and sustainability standpoint. The result is an attractive infill project that provides needed residential units, addresses the human scale while being sensitively designed to reduce impact on neighbouring properties.



#### Transmittal Page 2 of 2

In summary, the rationale for this project is as follows:

- i. Provide a thoughtful, sustainable infill housing solution to a property located within the core area of Kelowna.
- ii. A ground-oriented unit is provided along the fronting street which avoids dead frontages at the ground level and masks the off-street parking.
- iii. The proposed development meets the City of Kelowna Parking Bylaw requirements. Specifically, and in conjunction with zoning requirements, the project provides the required vehicle parking space for all 7 residences (11 stalls).
- iv. The proposed development results in a building design that is attractive in its design, is inviting and addresses the human scale at ground level as well is sensitive to the neighbourhood at large by the way it has been designed and massed on the site.
- v. The proposed development provides the required 6 short-term bicycle storge spaces and 7 long-term bicycle stalls, which can be accessed from the front or rear of the property.

This proposed development recognizes the City of Kelowna's strategic approach to overall growth including better use of precious developable land in accordance with the City's OCP/Future Land Use, Healthy City Strategy, and planning initiatives.

We look forward to your supportive comments in response to this Development Permit application.

Please do not hesitate to contact our office if you have any questions or require additional information in these matters.

Sincerely:


Matt Johnston /

Architect AIBC, LEED AP

LIME Architecture Inc.

# 2654 GORE STREET, KELOWNA, BC



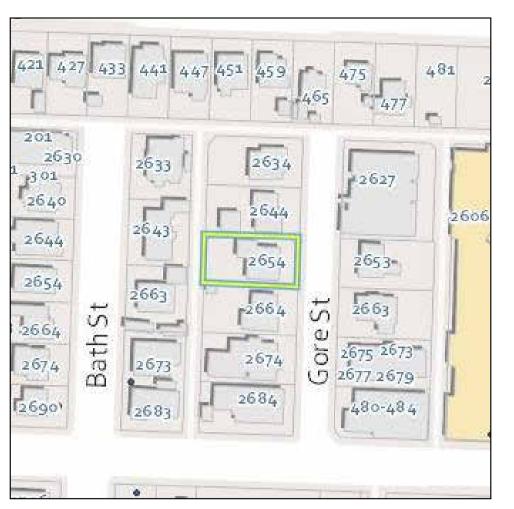

SITE KEY PLAN (NTS)

# ARCHITECTURAL SHEET LIST

<del>\</del> -000	COVER SHEET
<b>\-001</b>	LOCATION CONTEXT&OCP RESPONSE
<b>\-002</b>	SITE & PROJECT INFORMATION
<b>\</b> -101	LEVEL 1 PLAN
<b>\-102</b>	LEVEL 2 PLAN
<b>\</b> -103	LEVEL 3 PLAN
<b>\-104</b>	ROOFTOP DECK PLAN
<b>\-200</b>	FRONT ELEVATIONS
<b>\-201</b>	LEFT ELEVATIONS
<b>\-202</b>	BACK ELEVATIONS

RIGHT ELEVATIONS

COURTYARD ELEVATIONS

COURTYARD ELEVATIONS

A-203

ARCHITECTURE INC.
PHONE:250-448-7801

205-1626 Richter Street, Kelowna, BC V1Y 2M3

COPYRIGHT.
ALL RIGHTS RESERVED

All ideas, designs, drawings and specifications are the exclusive property of LIME Architecture Inc. As instruments of service, they may not be used or reproduced in any manner without the expressed written consent of LIME Architecture Inc. All Contracting Trades shall check and verify all levels, dimensions, data and conditions on the site prior to commencement of any work. Any discrepancies are to be reported immediately to LIME Architecture Inc. Do not Scale any dimensions from this drawing.

All trades are to execute the work in accordance with the current municipality building by-laws and requirements of other local authorities having jurisdiction as well as the british columbia building code - (most recent edition) including all published revisions and addenda. All trades shall assume full responsiblity for the locations and protection of all under and above ground utilities, wires and conduit connections, including (but not limited to) water, sewer, gas, hydro and telephone.

# Revision No., Date and Description

10.03.23 90% DP REVIEW 12.19.23 FOR DP

PROPERTY DESCRIPTION

CIVIC: 2654 GORE STREET, KELOWNA, BC LEGAL: LOT 4, PLAN KAP7927

# CONSULTANT TEAM

Justice Marks

OWNER/ OPERATOR	<u>ARCHITECTURAL</u>	<u>LANDSCAPING</u>
Okanagan Infill 101-540 Groves Avenue Kelowna, BC V1Y 4Y7 250-826-9888	LIME Architecture 205-1626 Richter Street Kelowna, BC V1Y 2M3 250-448-7801	Ecora 200-2406 Enterprise Way Kelowna, BC V1Y 9T5 250-469-9757
Contact(s):	Contact(s):	Contact(s):

Po Ho


Jenessa Kehl

PROJECT
2654 GORE S

2654 GORE STREET

DRAWING TITLE


COVER SHEET

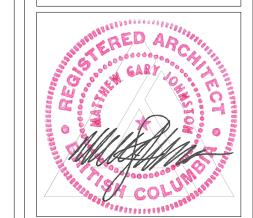


# Site Description & Current Conditions

The proposed development is a single lot located mid-block on Gore Street, with parkade access from a lane. Located in the Pandosy Urban Centre, a vibrant and developing area with many amenities, the proposed 3-storey building will fit seamlessly in the developing neighbourhood.


The site is within close proximity to grocery and retail stores, restaurants, schools and parks. There is frequent transit with bus stops nearby and the site is near a primary bicycle route.

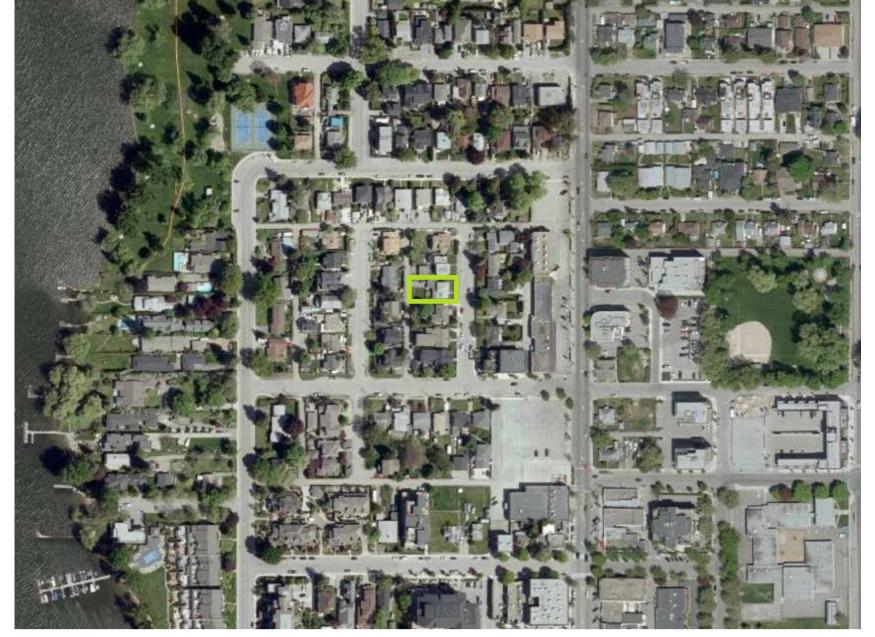

SITE LOCATION

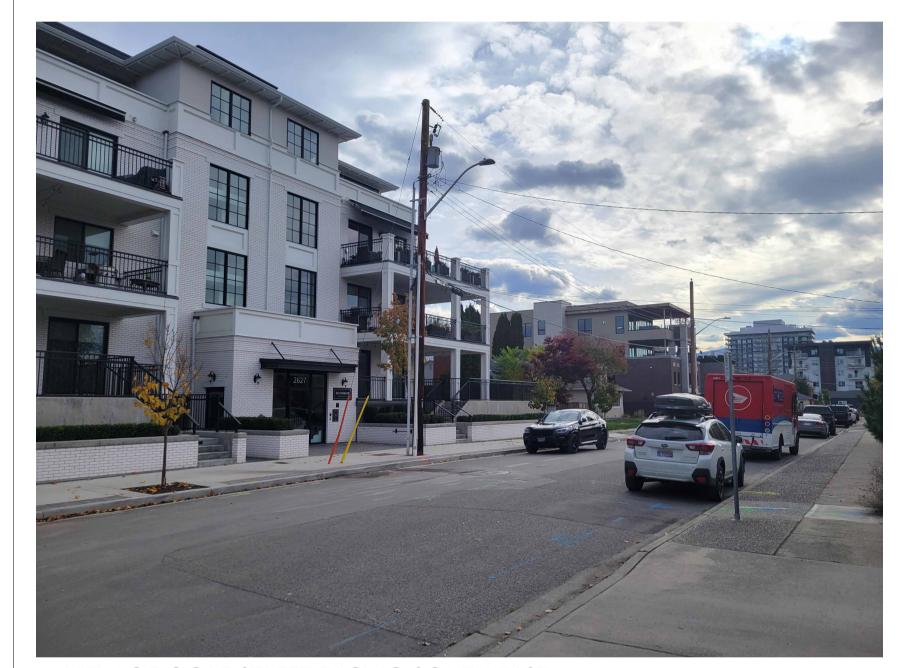

1. VIEW OF GORE STREET FACING SOUTH EAST

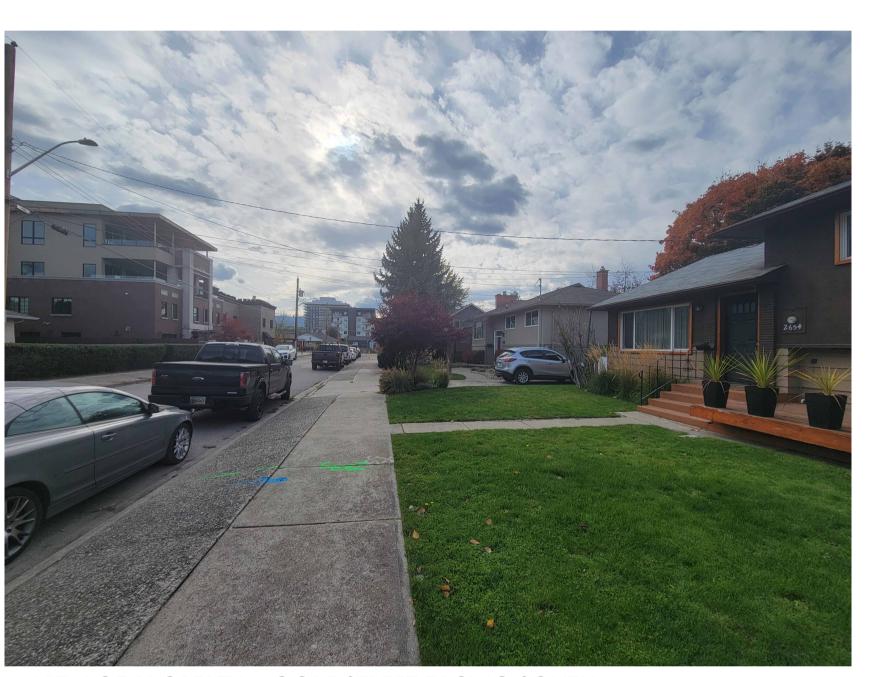

2. VIEW OF PROPERTY & GORE STREET FACING SOUTH

# Response to Form & Character

# Relationship to Street Guidelines

Ensure lobbies are clearly visible from the fronting street

- The lobby is located on the front corner of the building
- Significant amounts of glazing have been provided to ensure the lobby is clearly visible
- An entrance canopy defines the primary entrance into the building

Avoid blank walls at grade wherever possible:

 A ground-oriented unit is provided along the fronting street which avoids dead frontages at the ground level and masks the off-street parking

# Scale and Massing Guidelines

Ensure buildings provide a sensitive transition to existing and future buildings:

- The building height is lower than the zoning bylaw allowance
- There are existing buildings on the street that are 4 storeys in height, while the proposed is only 3 storeys

# Site Servicing, Access and Parking

Provide adequate servicing, vehicle access and parking while maintaining safety and attractiveness of the public realm:

- Off-street parking, garbage pickup, and the transformer are accessed from the rear lane
- Bicycle parking within the building is accessible from the front and rear of the property

# Building Articulation, Features, & Material Guidelines

Articulate building facades into intervals:


- Portions of the building are stepped back
- Different colours and materials are proposed at intervals
- Window patterning alternates to correspond with intervals

Enhance liveability, visual interest, and sense of place:


• The building facade is articulated with design elements that are inherent to the building



SITE CONDITION KEY MAP

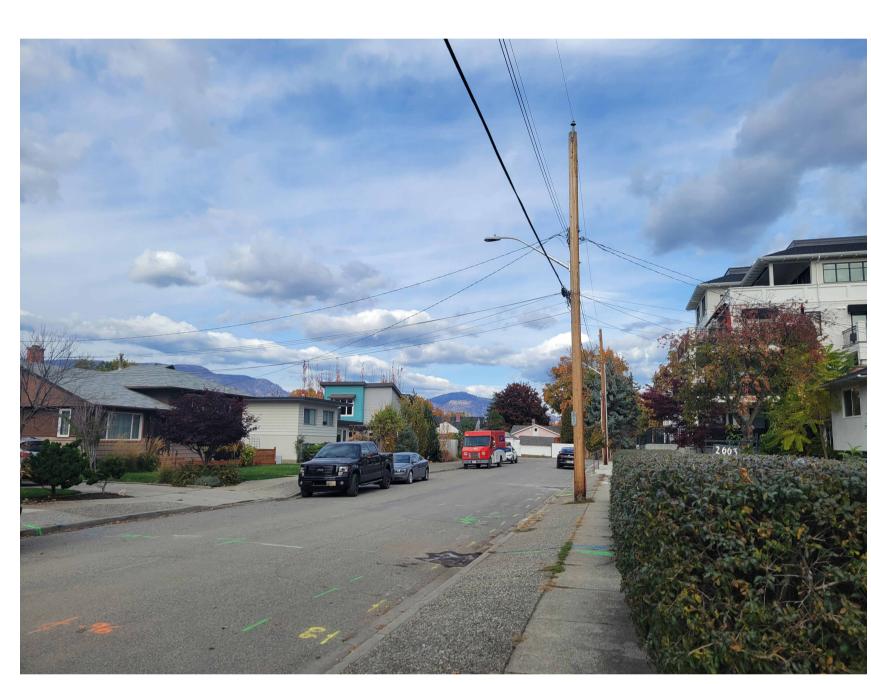

3. VIEW OF PROPERTY & GORE STREET FACING NORTH

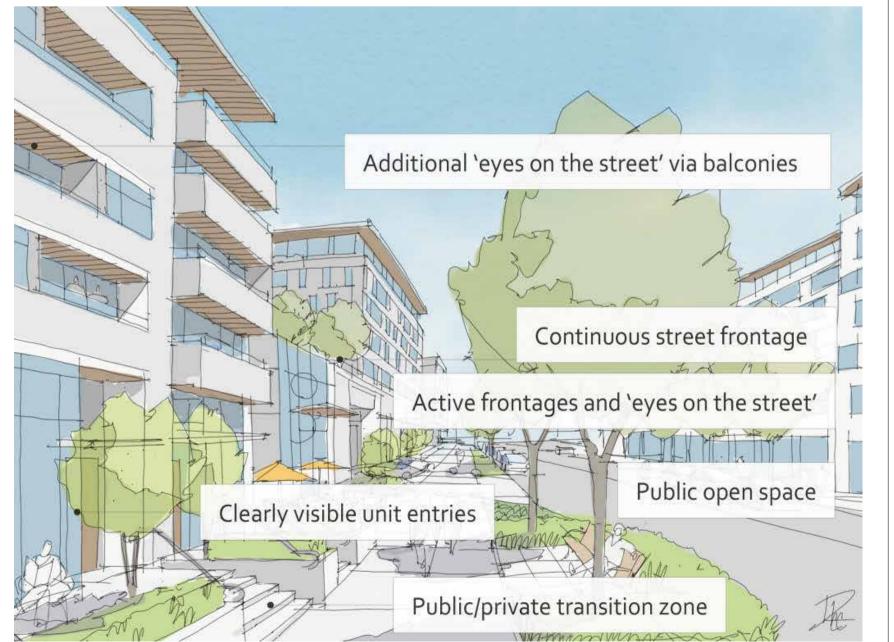

2040 OCP Relationship to Street Graphic



205-1626 Richter Street, Kelowna, BC V1Y 2M3

COPYRIGHT.

ALL RIGHTS RESERVED

All ideas, designs, drawings and specifications are the exclusive property of LIME Architecture Inc. As instruments of service, they may not be used or reproduced in any manner without the expressed written consent of LIME Architecture Inc. All Contracting Trades shall check and verify all levels, dimensions, data and conditions on the site prior to commencement of any work. Any discrepancies are to be reported immediately to LIME Architecture Inc. Do not Scale any dimensions from this drawing.

All trades are to execute the work in accordance with the current municipality building by-laws and requirements of other local authorities having jurisdiction as well as the british columbia building code - (most recent edition) including all published revisions and addenda. All trades shall assume full responsiblity for the locations and protection of all under and above ground utilities, wires and conduit connections, including (but not limited to) water, sewer, gas, hydro and telephone.

Revision No., Date and Description

12.19.23 FOR DP

PROJECT
2654 GORE STREET

DRAWING TITLE

LOCATION
CONTEXT&OCP
RESPONSE

Drawing No.

A-001

FOR DP

**Plot Date** 

# LOT 4 GORE STREET, KELOWNA, BC

# PROPERTY DESCRIPTION:

CIVIC: 2654 GORE STREET, KELOWNA, BC LEGAL: LOT 4, PLAN KAP7927

# **ZONING CALCULATIONS:**

CURRENT: CITY OF KELOWNA UC5 ZONING PANDOSY URBAN CENTRE OCP MAP 4.5: 4 STOREYS OCP MAP 4.6: RESIDENTIAL STREET

# **SITE INFORMATION:**

GROSS SITE AREA = 6,889 SF (640 m<sup>2</sup>)

ALLOWED/REQUIRED <u>PROPOSED</u> SITE COVERAGE = 85% (5,856 SF) 82% (5,804 SF) SITE COVERAGE + HARDSCAPING =90% (6,200 SF) 85% (5,845 SF) FAR =1.6 (11,023 SF) 1.2 (8,379 SF) HEIGHT = 10.8m (3 STOREYS) 18.0m (4 STOREYS)

PRIVATE & COMMON AMENITY SPACE:

 $7 \text{ UNITS x } 4\text{m}^2/\text{UNIT} = 28\text{m}^2 (301 \text{ SF})$ COMMON = 604 SF

PRIVATE: 2+ BEDROOM UNITS = 11m<sup>2</sup>/UNIT (118 SF) 305-886 SF/UNIT (SEE TABLE)

YARD SETBACKS:

FRONT YARD = 3.0m 5.0m SIDE YARD = 0.0 m0.07m SIDE YARD =0.0 m0.03 m0.0m REAR YARD =0.15m

PARKING CALCULATIONS:

2+ BEDROOM UNITS =  $7 \text{ UNITS x } 1.0 \text{ (MIN.)} = 7^*$ VISITOR =7 UNITS x 0.14 = 1TOTAL = 1 (0 VAN ACCESSIBLE) ACCESSIBLE PARKING = 1 (0 VAN ACCESSIBLE) \*MAX. ALLOWABLE: 1.5/UNIT = 11

LONG-TERM BICYCLE STORAGE: 5 UNITS x 0.75 = 42 BEDROOM UNITS = 3 BEDROOM UNITS = 2 UNITS x 1 = 2

TOTAL =

SHORT-TERM BICYCLE STORAGE:

6 PER ENTRANCE =

	UNIT	CALCULATIO	NS
UNIT	# OF BEDROOMS	UNIT AREA	PRIVATE AMENITY SPACE
1	2	865 SF	305 SF
2	3	1376 SF	763 SF
3	2	1289 SF	629 SF
4	2	1260 SF	615 SF
5	3	1282 SF	886 SF
6	2	1167 SF	764 SF
7	2	1140 SF	757 SF
TOTAL UNI	T AREAS	8378 SF	

	PARKING
COUNT	TYPE
1	ACCESSIBLE - 90 deg
6	REGULAR - 90 deg
4	SMALL - 90 deg
4.4	



- LINE OF LEVEL ABOVE TRANSFORMER 59' - 7 1/4" 6 SHORT-TERM BICYCLE STALLS WALKWAY ----1800 18.27m PROPERTY LINE SURVEY PROVIDED BY FERGUSON LAND SURVEYING & GEOMATICS. DATED APRIL 25, 2023 GORE STREET

LANE

18.27m PROPERTY LINE



205-1626 Richter Street, Kelowna, BC V1Y 2M3 www.limearchitecture.com

COPYRIGHT. ALL RIGHTS RESERVED

> All ideas, designs, drawings and specifications are the exclusive property of LIME Architecture Inc. As instruments of service, they may not be used or reproduced in any manner without the expressed written consent of LIME Architecture Inc. All Contracting Trades shall check and verify all levels, dimensions, data and conditions on the site prior to commencement of any work. Any discrepancies are to be reported immediately to LIME Architecture Inc. Do not Scale any dimensions from this drawing.

All trades are to execute the work in accordance with the current municipality building by-laws and requirements of other local authorities having jurisdiction as well as the british columbia building code -(most recent edition) including all published revisions and addenda. All trades shall assume full responsiblity for the locations and protection of all under and above ground utilities, wires and conduit connections, including (but not limited to) water, sewer, gas, hydro and telephone.

**Revision No., Date** and Description

10.03.23 90% DP REVIEW 12.18.23 FOR REVIEW 12.19.23 FOR DP


Plot Date 12.19.23 PROJECT

2654 GORE STREET DRAWING TITLE

SITE & PROJECT INFORMATION

Drawing No.



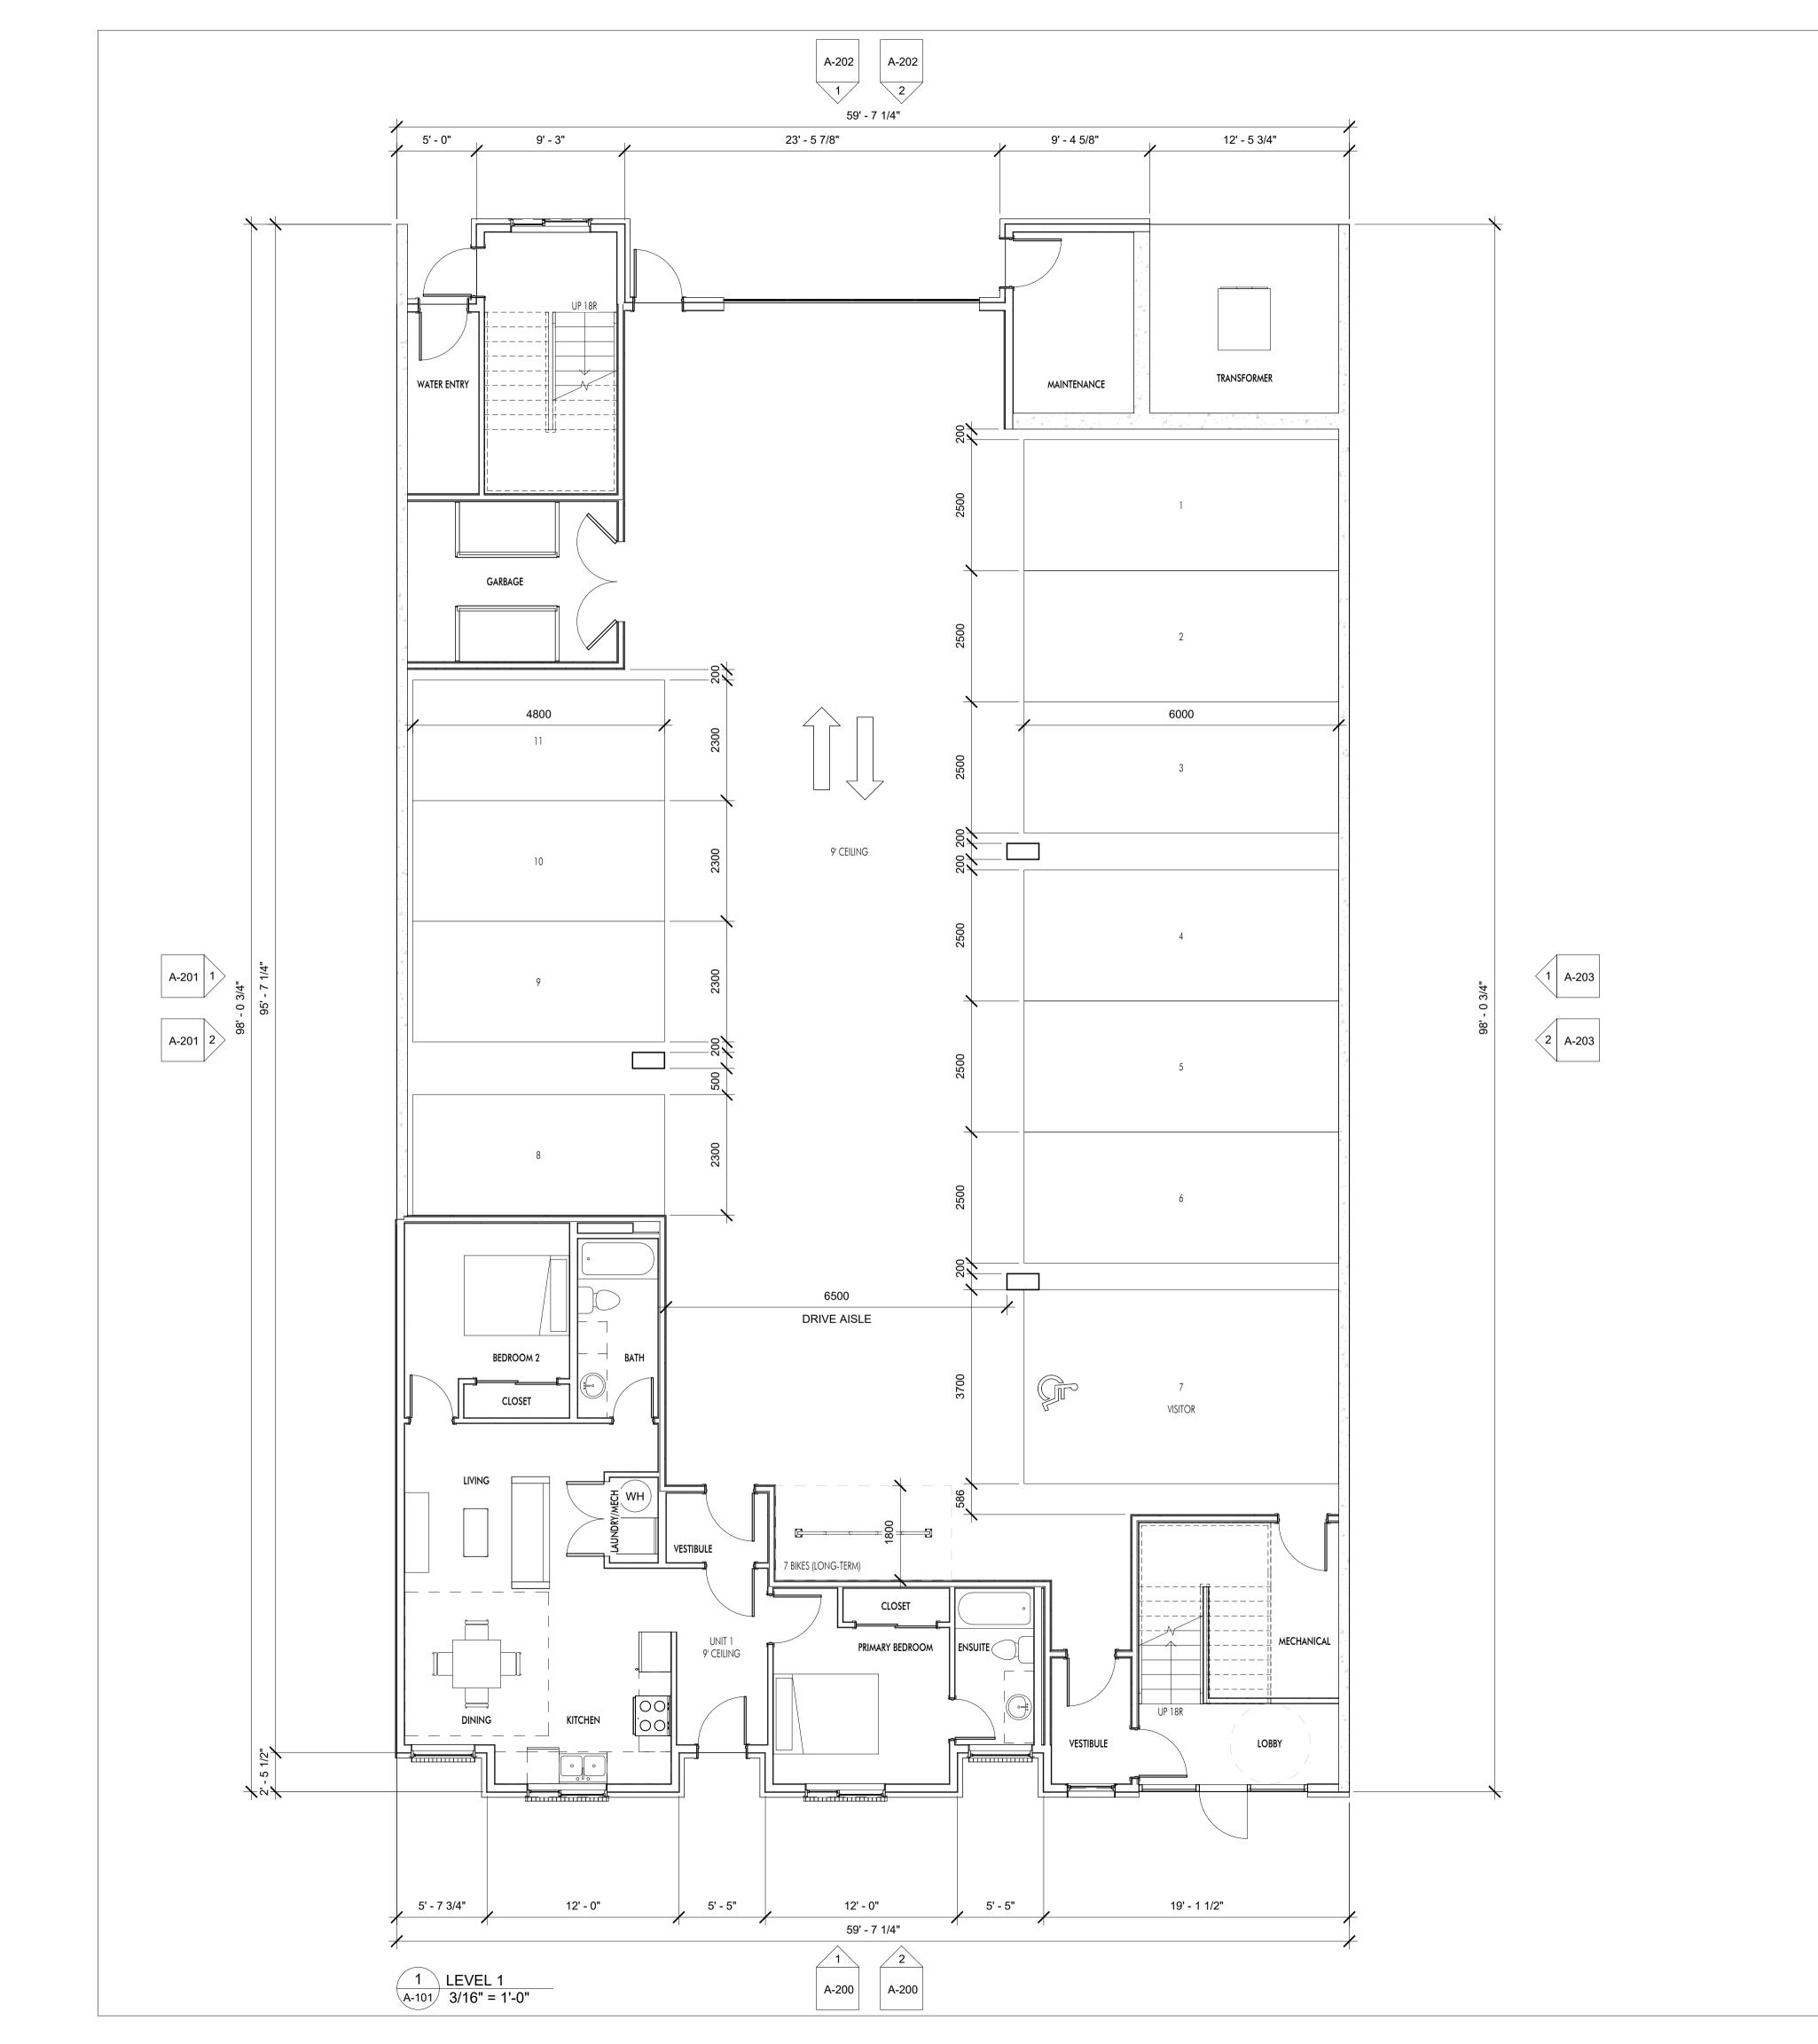



205-1626 Richter Street, Kelowna, BC V1Y 2M3 www.limearchitecture.com

COPYRIGHT. ALL RIGHTS RESERVED

All ideas, designs, drawings and specifications are the exclusive property of LIME Architecture Inc. As instruments of service, they may not be used or reproduced in any manner without the expressed written consent of LIME Architecture Inc. All Contracting Trades shall check and verify all levels, dimensions, data and conditions on the site prior to commencement of any work. Any discrepancies are to be reported immediately to LIME Architecture Inc. Do not Scale any dimensions from this drawing.

All trades are to execute the work in accordance with the current municipality building by-laws and requirements of other local authorities having jurisdiction as well as the british columbia building code - (most recent edition) including all published revisions and addenda. All trades shall assume full responsiblity for the locations and protection of all under and above ground utilities, wires and conduit connections, including (but not limited to) water, sewer, gas, hydro and telephone.

# Revision No., Date and Description

04.18.23 SCHEMATIC PLANS 06.30.23 SCHEMATIC PLANS 09.22.23 FOR REVIEW 10.03.23 90% DP REVIEW

12.18.23 FOR REVIEW 12.19.23 FOR DP


Plot Date 12.19.23 PROJECT


2654 GORE STREET

DRAWING TITLE

LEVEL 1 PLAN

D.......

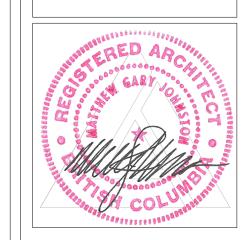

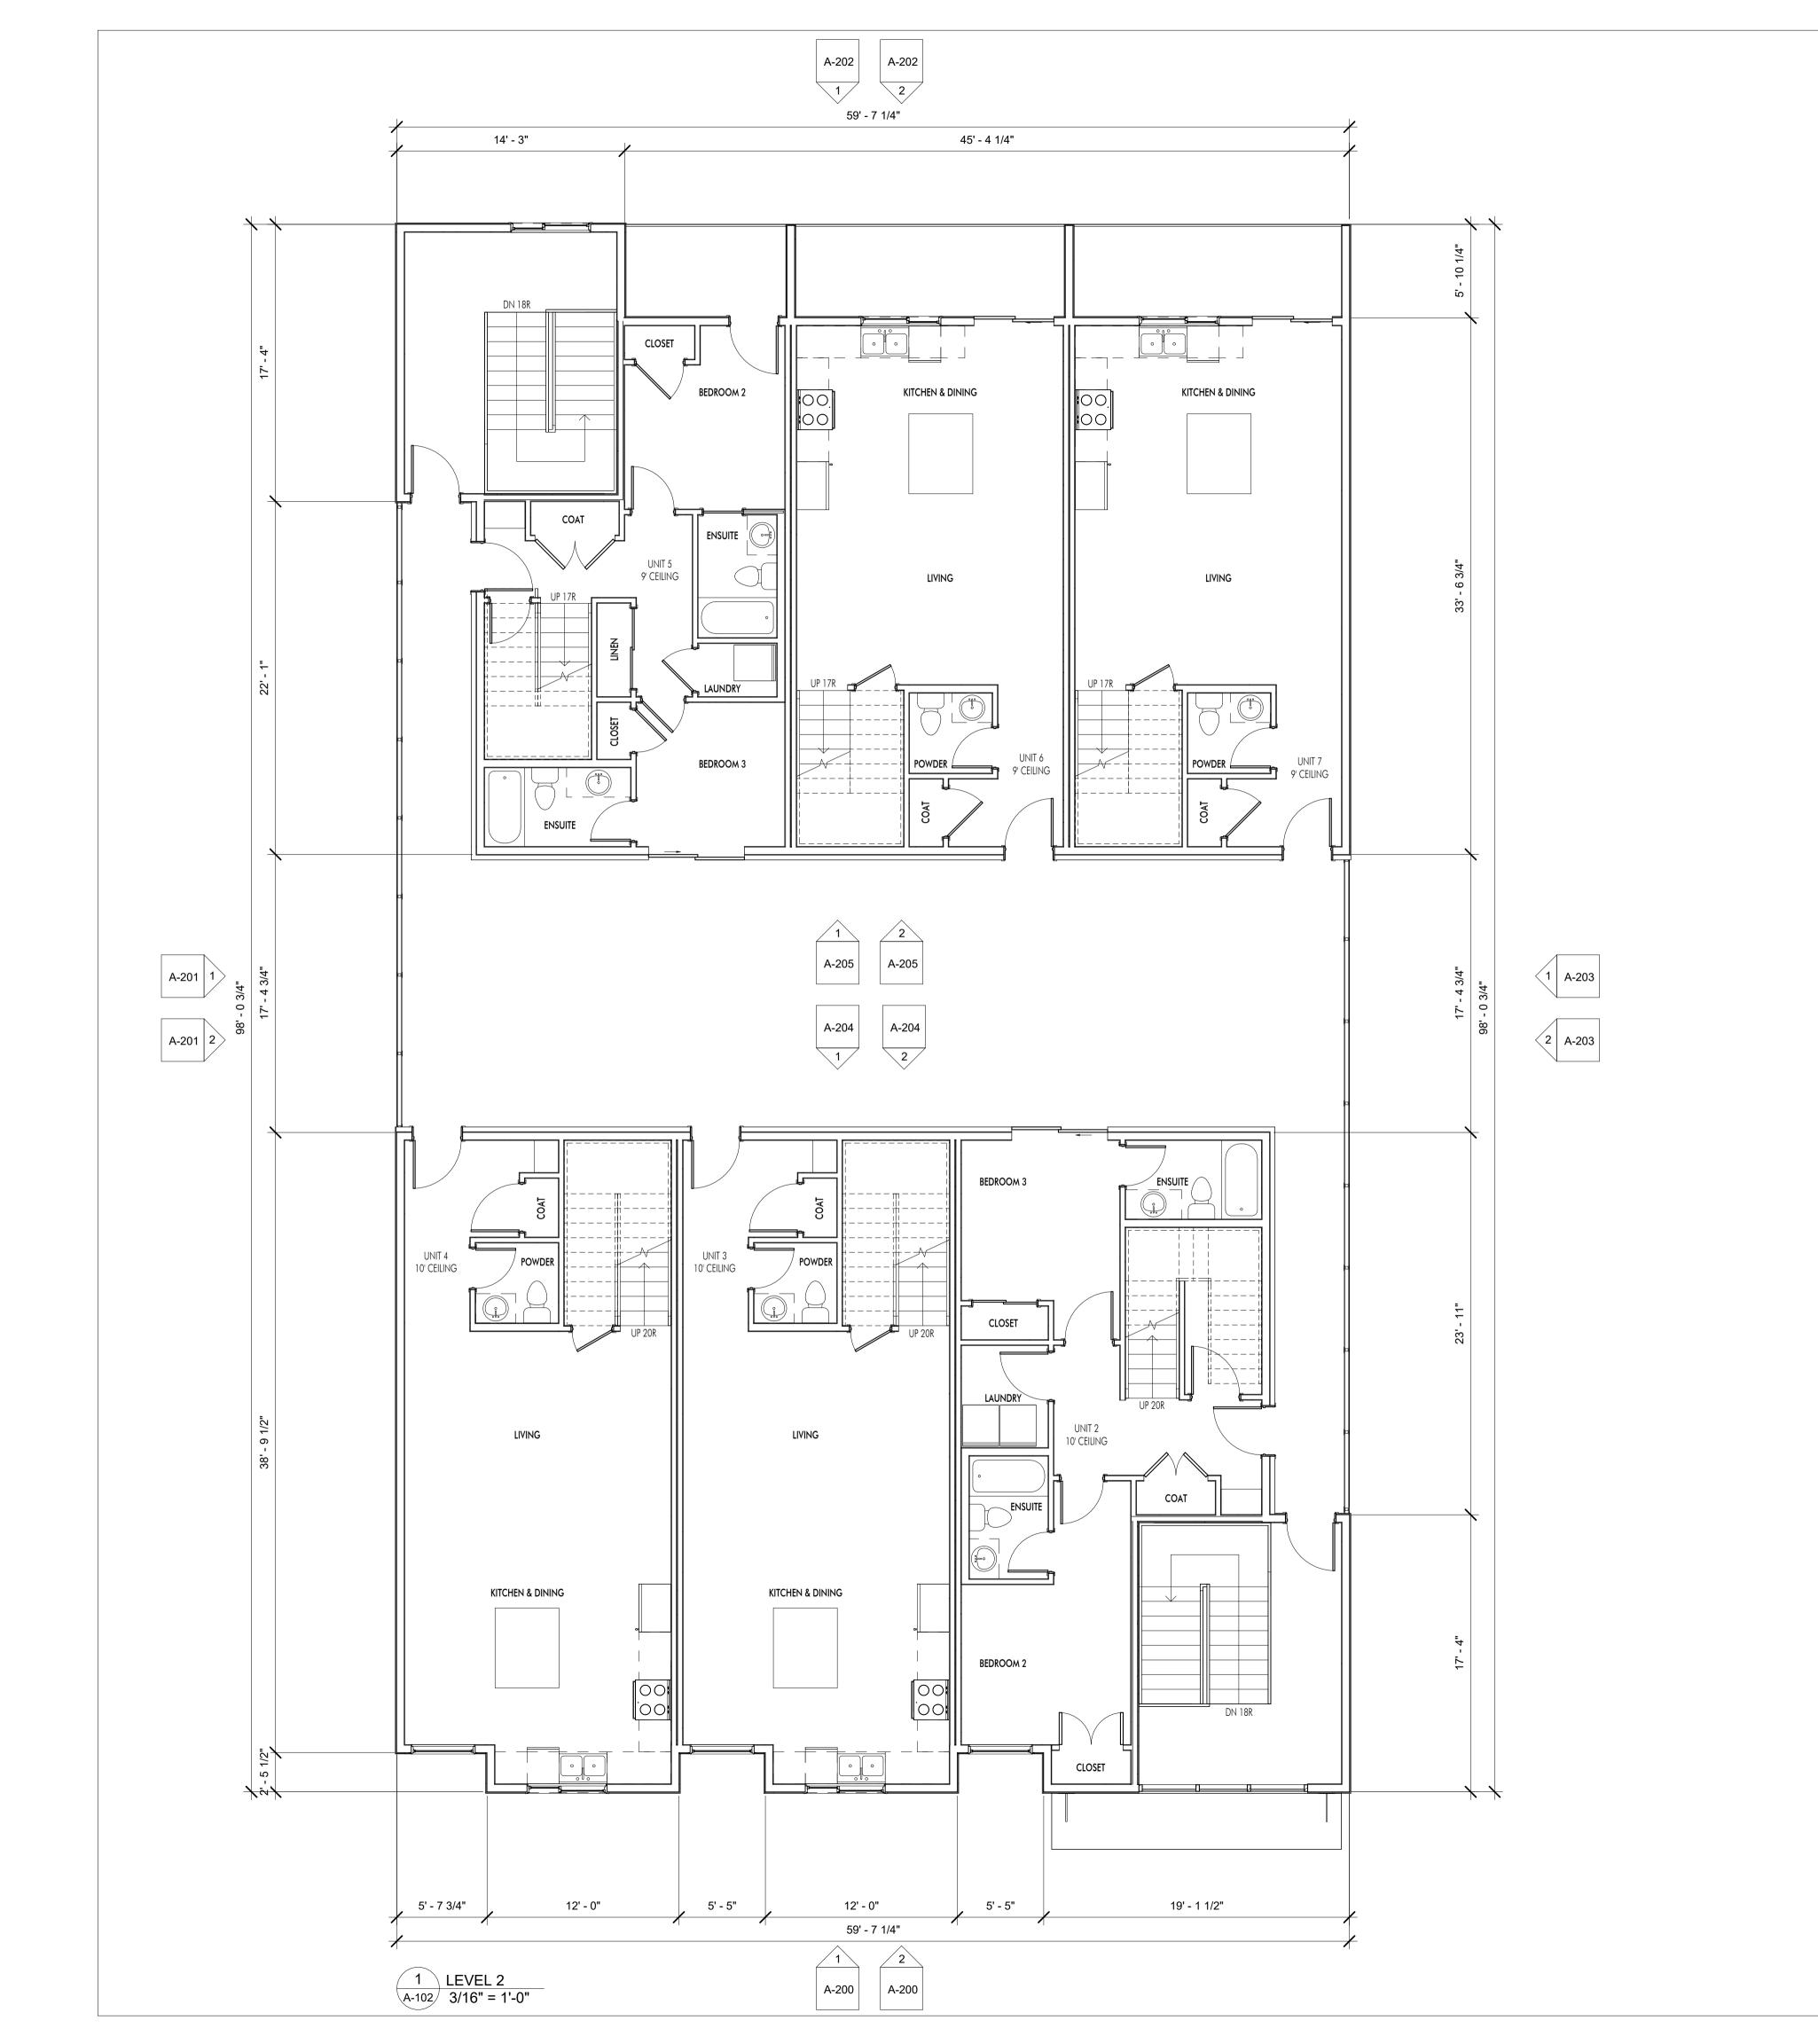



205-1626 Richter Street, Kelowna, BC V1Y 2M3 www.limearchitecture.com

COPYRIGHT. ALL RIGHTS RESERVED

All ideas, designs, drawings and specifications are the exclusive property of LIME Architecture Inc. As instruments of service, they may not be used or reproduced in any manner without the expressed written consent of LIME Architecture Inc. All Contracting Trades shall check and verify all levels, dimensions, data and conditions on the site prior to commencement of any work. Any discrepancies are to be reported

immediately to LIME Architecture Inc. Do

not Scale any dimensions from this drawing.

All trades are to execute the work in accordance with the current municipality building by-laws and requirements of other local authorities having jurisdiction as well as the british columbia building code - (most recent edition) including all published revisions and addenda. All trades shall assume full responsibility for the locations and protection of all under and above ground utilities, wires and conduit connections, including (but not limited to) water, sewer, gas, hydro and telephone.

### Revision No., Date

and Description

04.18.23 SCHEMATIC PLANS

05.10.23 SCHEMATIC PLANS

06.30.23 SCHEMATIC PLANS

07.19.23 SCHEMATIC PLANS

07.28.23 SCHEMATIC PLANS

09.22.23 FOR REVIEW

10.03.23 90% DP REVIEW


| 10.03.23 | 90% DP REVIEW | 12.18.23 | FOR REVIEW | 12.19.23 | FOR DP


**Plot Date** 12.19.23

PROJECT
2654 GORE STREET

DRAWING TITLE

LEVEL 2 PLAN

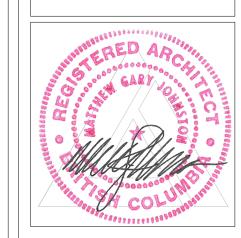

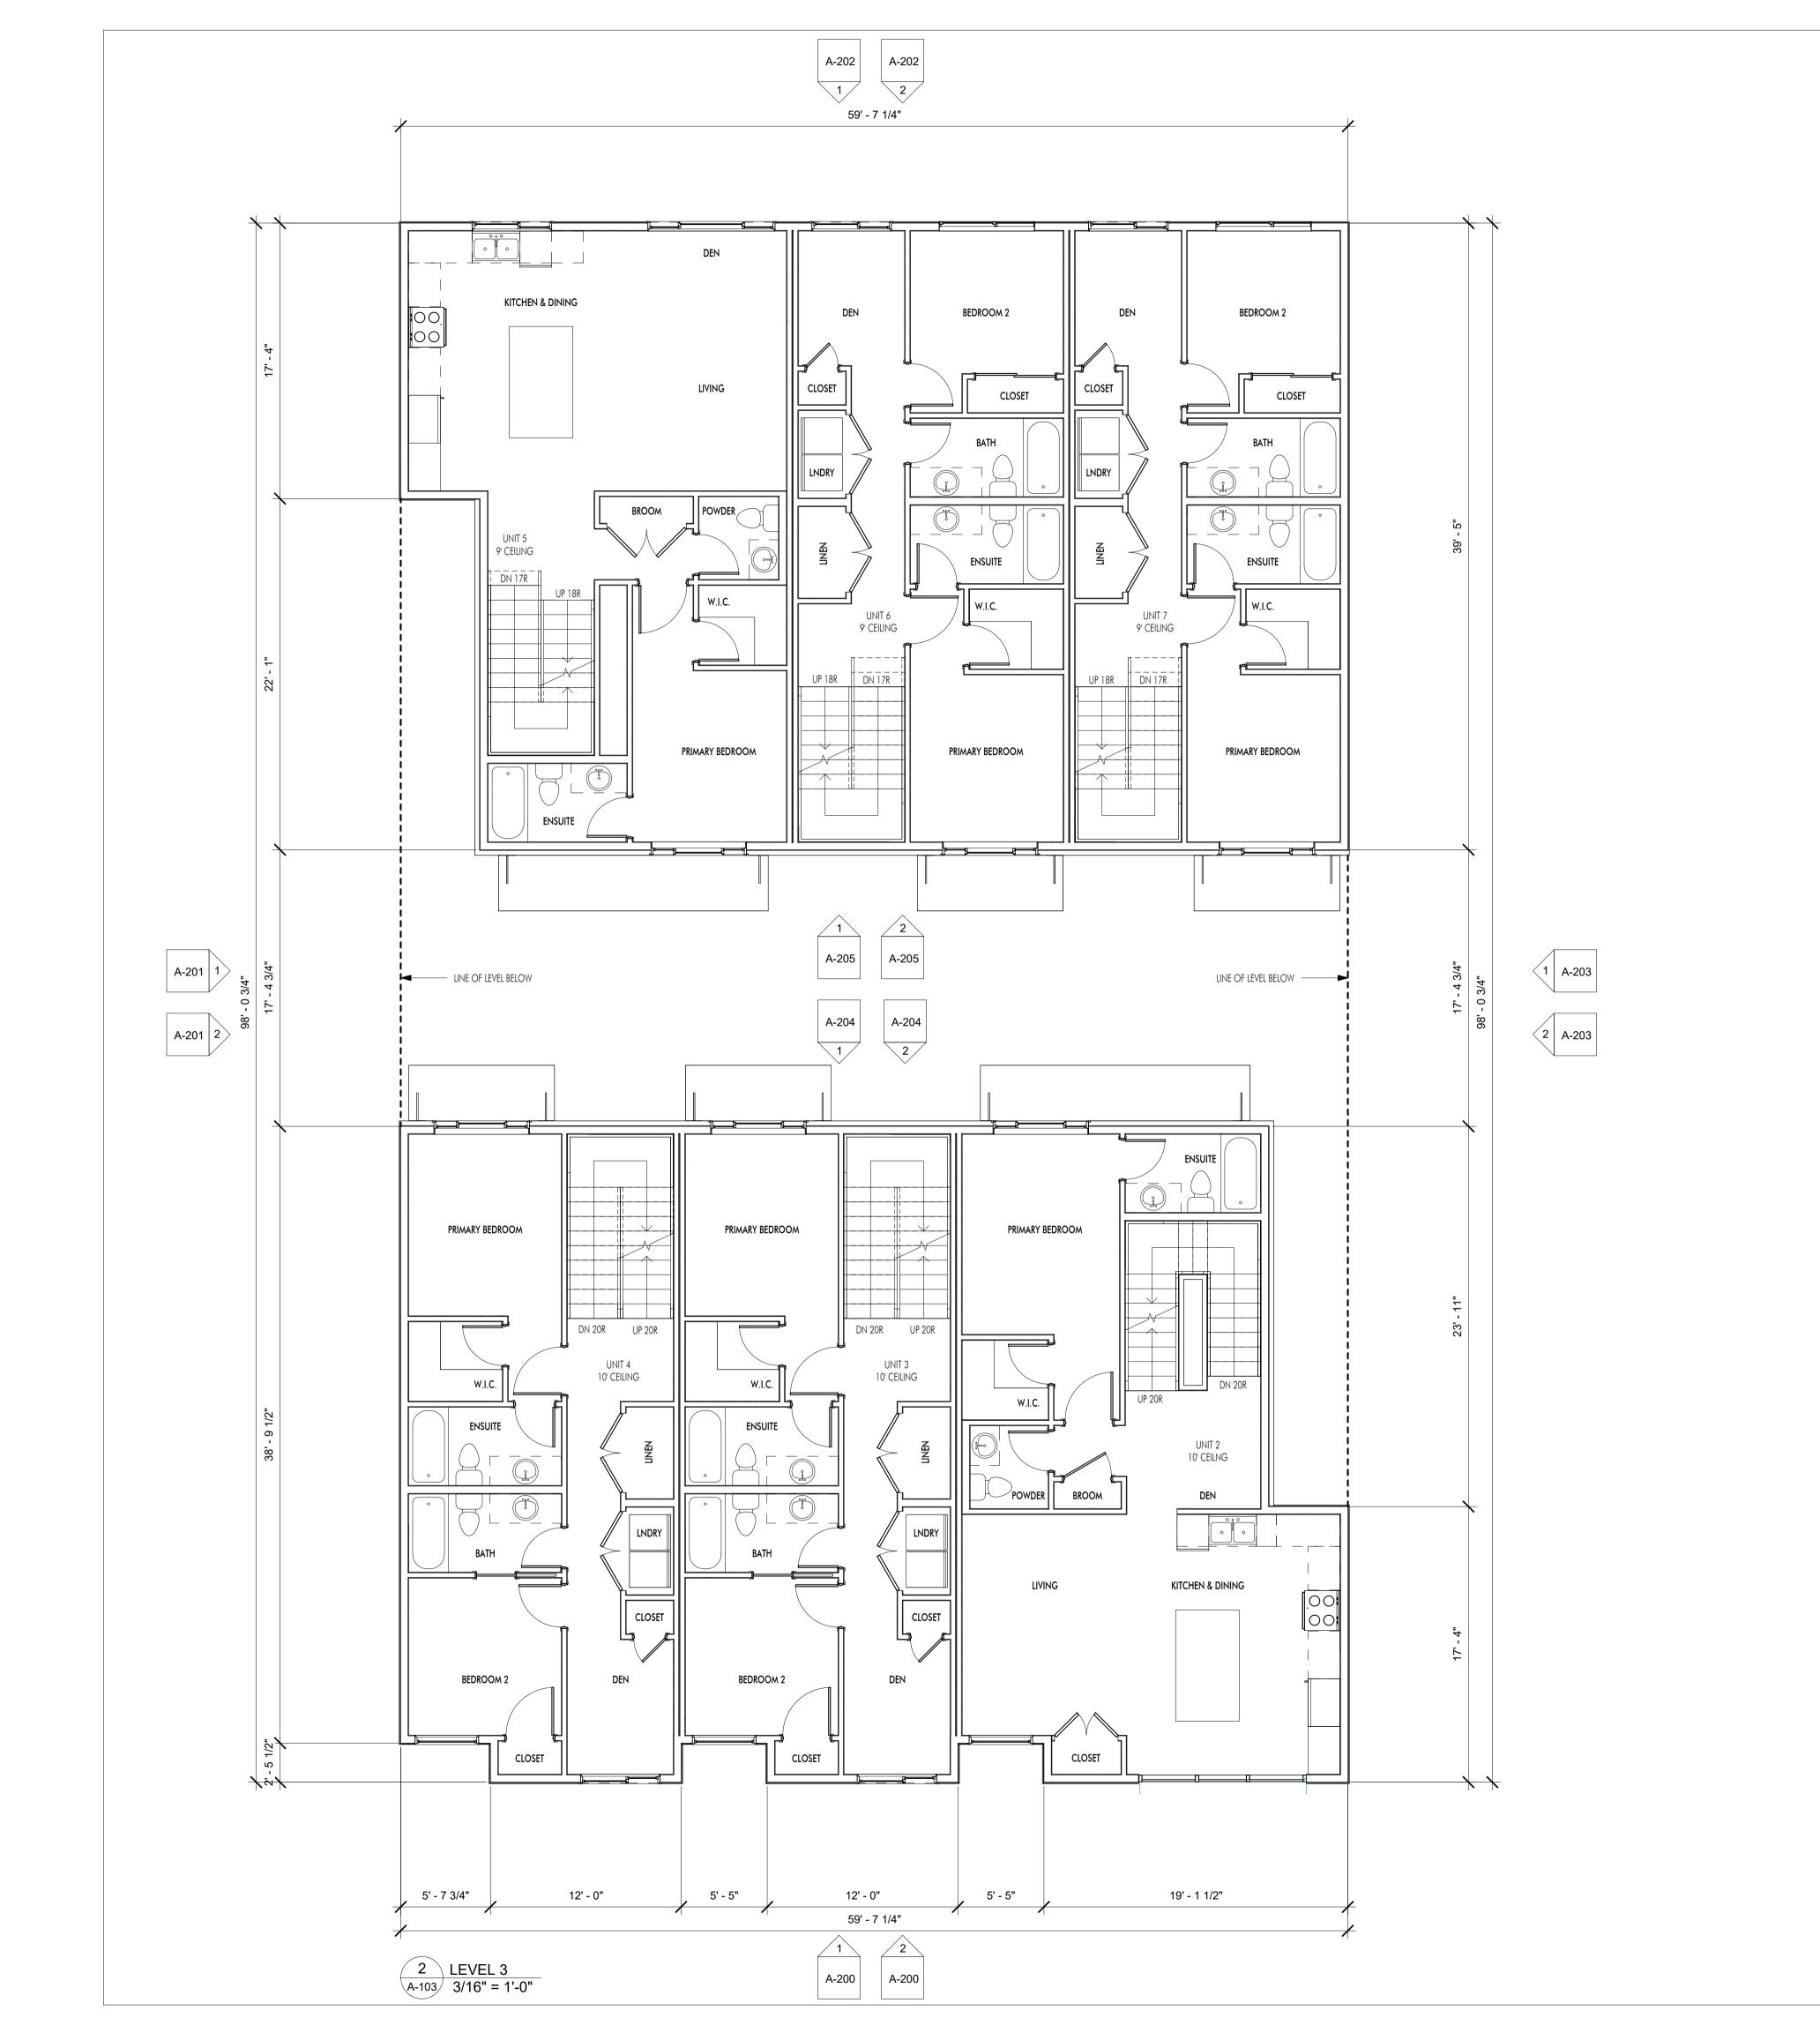



205-1626 Richter Street, Kelowna, BC V1Y 2M3

www.limearchitecture.com

COPYRIGHT.
ALL RIGHTS RESERVED

All ideas, designs, drawings and specifications are the exclusive property of LIME Architecture Inc. As instruments of service, they may not be used or reproduced in any manner without the expressed written consent of LIME Architecture Inc. All Contracting Trades shall check and verify all levels, dimensions, data and conditions on the site prior to commencement of any work. Any discrepancies are to be reported

immediately to LIME Architecture Inc. Do

not Scale any dimensions from this drawing.

All trades are to execute the work in accordance with the current municipality building by-laws and requirements of other local authorities having jurisdiction as well as the british columbia building code - (most recent edition) including all published revisions and addenda. All trades shall assume full responsibility for the locations and protection of all under and above ground utilities, wires and conduit connections, including (but not limited to) water, sewer, gas, hydro and telephone.

# Revision No., Date and Description

04.18.23 SCHEMATIC PLANS
05.10.23 SCHEMATIC PLANS
06.30.23 SCHEMATIC PLANS
07.19.23 SCHEMATIC PLANS
07.28.23 SCHEMATIC PLANS
09.22.23 FOR REVIEW
10.03.23 90% DP REVIEW
12.18.23 FOR REVIEW

12.19.23 FOR DP


**Plot Date** 12.19.23


PROJECT
2654 GORE STREET

DRAWING TITLE

LEVEL 3 PLAN

\_ . . .

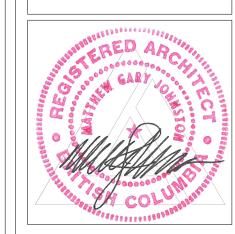

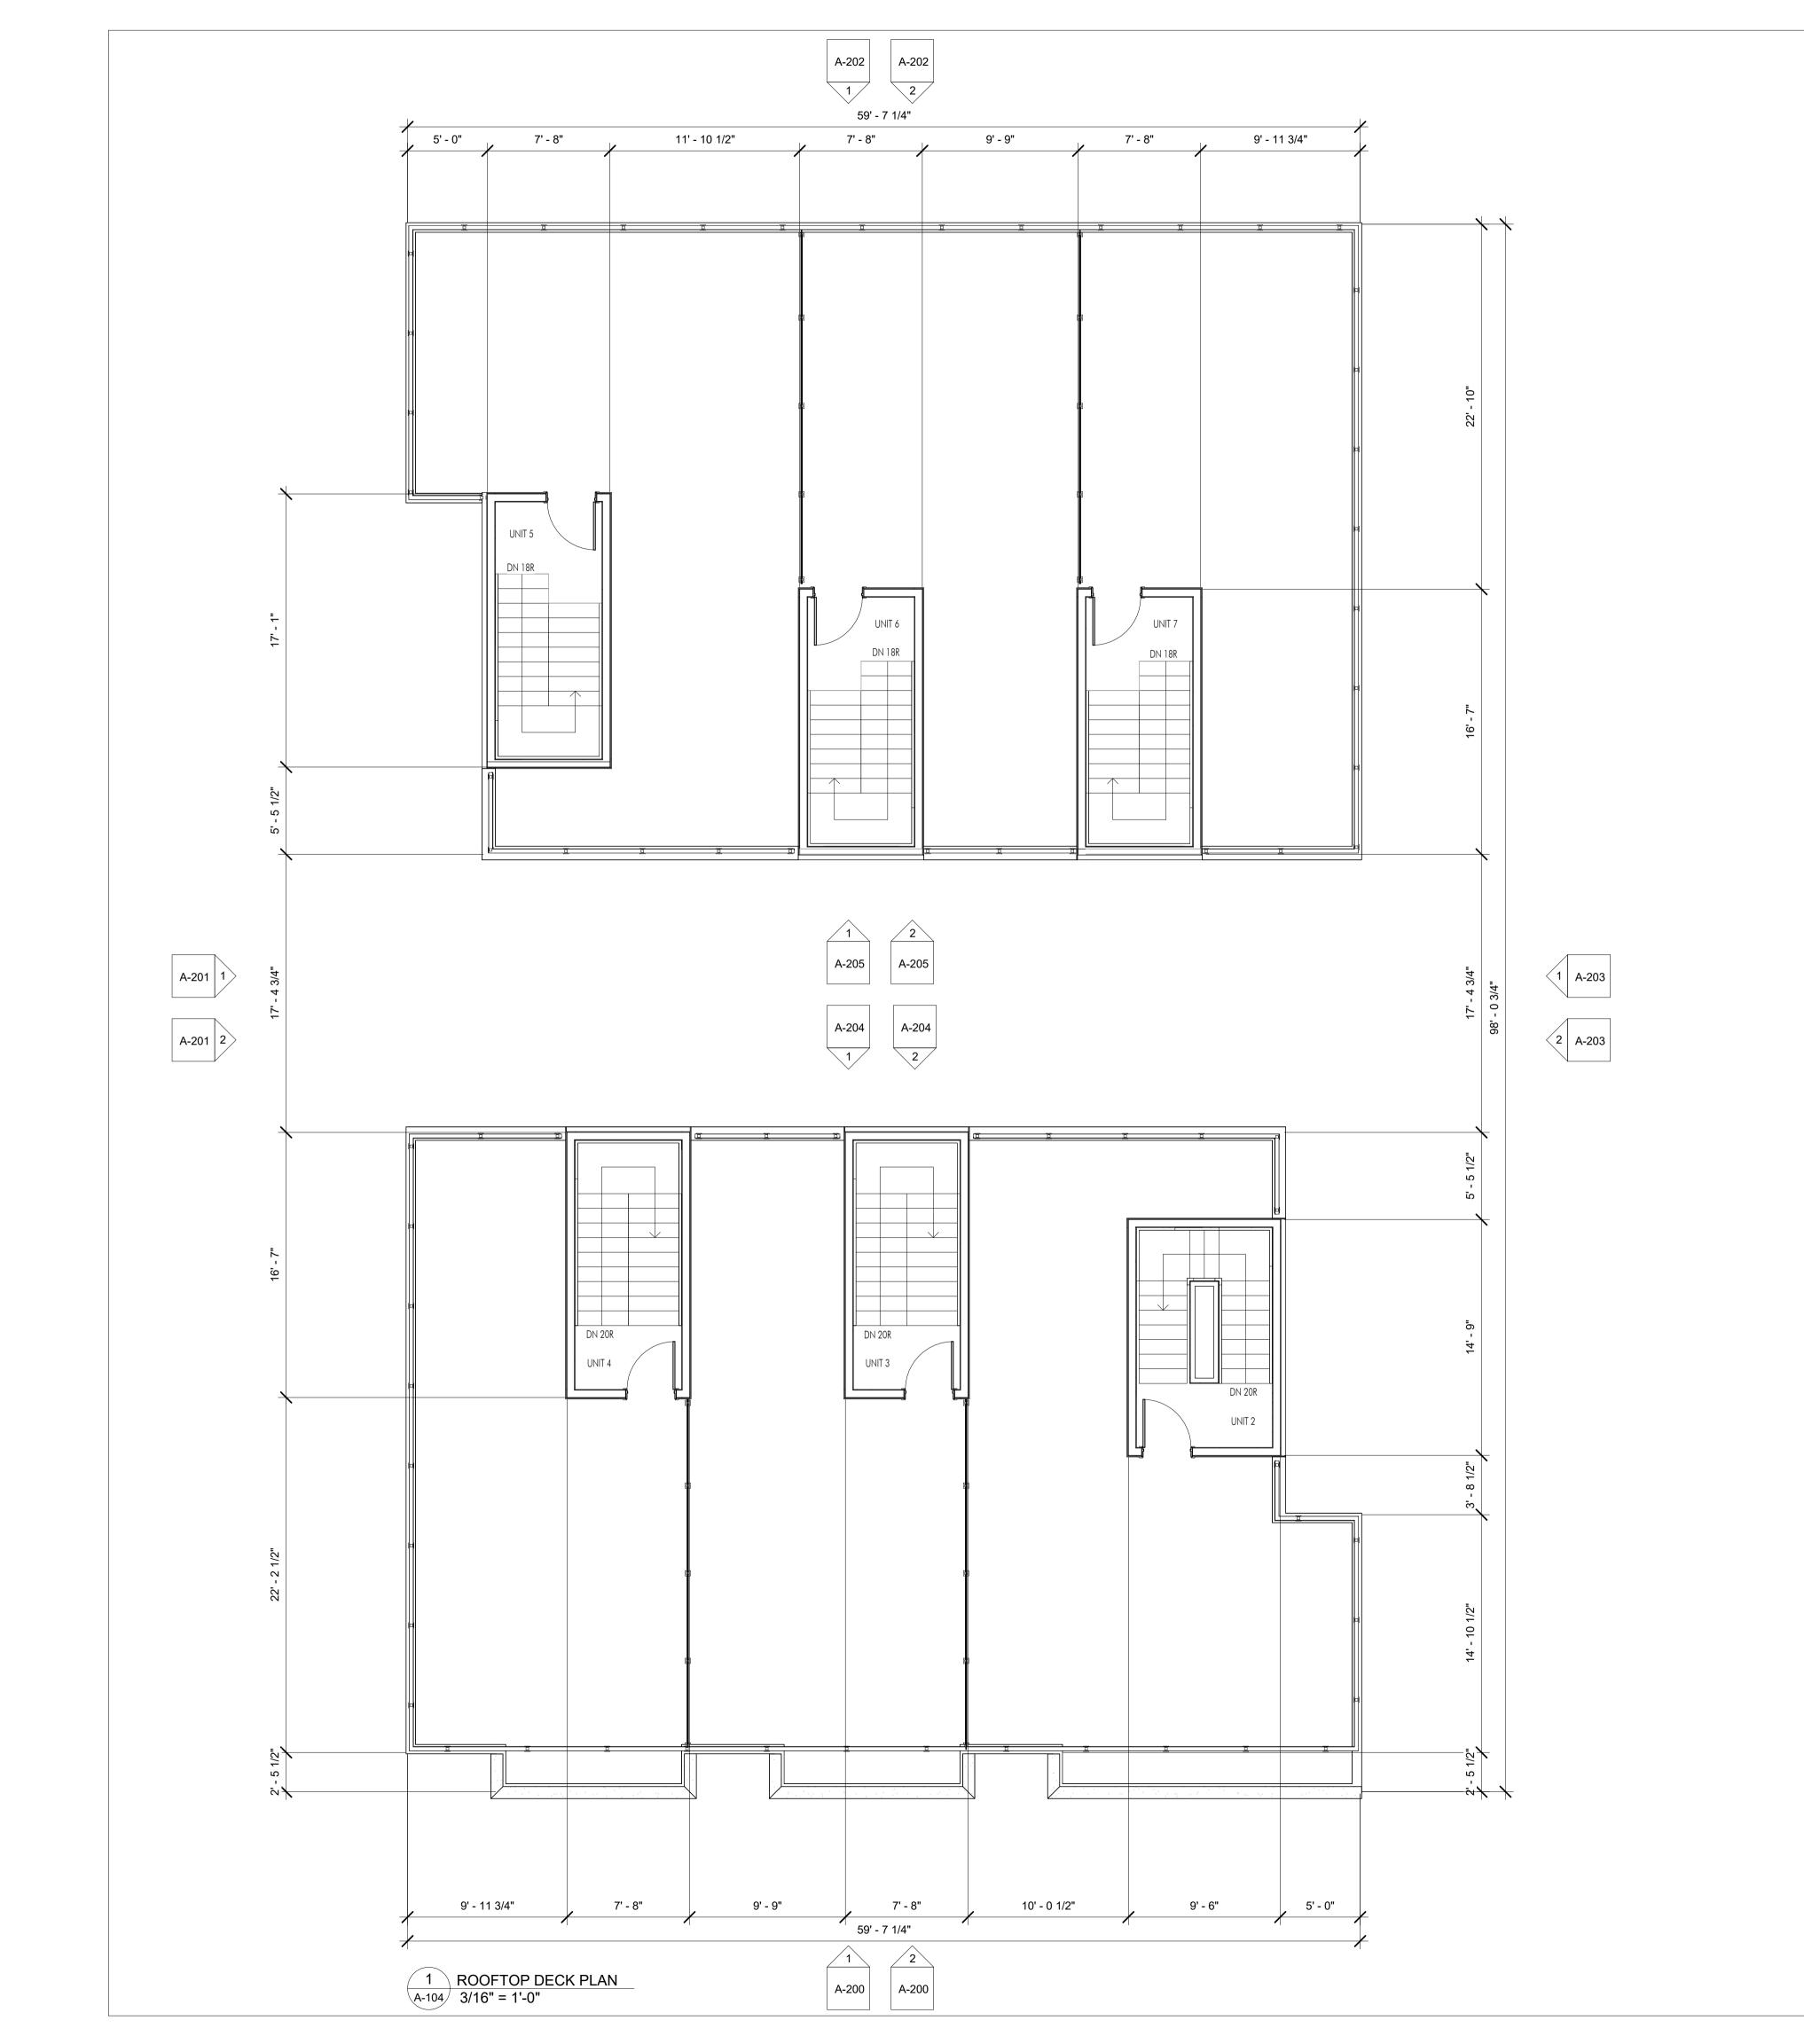



205-1626 Richter Street, Kelowna, BC V1Y 2M3 www.limearchitecture.com

COPYRIGHT.
ALL RIGHTS RESERVED

All ideas, designs, drawings and specifications are the exclusive property of LIME Architecture Inc. As instruments of service, they may not be used or reproduced in any manner without the expressed written consent of LIME Architecture Inc. All Contracting Trades shall check and verify all levels, dimensions, data and conditions on the site prior to commencement of any work. Any discrepancies are to be reported immediately to LIME Architecture Inc. Do not Scale any dimensions from this drawing.

All trades are to execute the work in accordance with the current municipality building by-laws and requirements of other local authorities having jurisdiction as well as the british columbia building code - (most recent edition) including all published revisions and addenda. All trades shall assume full responsibility for the locations and protection of all under and above ground utilities, wires and conduit connections, including (but not limited to) water, sewer, gas, hydro and telephone.

### Revision No., Date and Description

and Description

04.18.23 SCHEMATIC PLANS

05.10.23 SCHEMATIC PLANS

06.30.23 SCHEMATIC PLANS

10.03.23 90% DP REVIEW

12.18.23 FOR REVIEW

12.19.23 FOR DP


**Plot Date** 12.19.23

PROJECT
2654 GORE STREET


DRAWING TITLE

ROOFTOP DECK PLAN

Drawing N

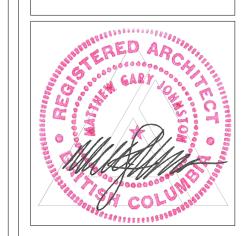



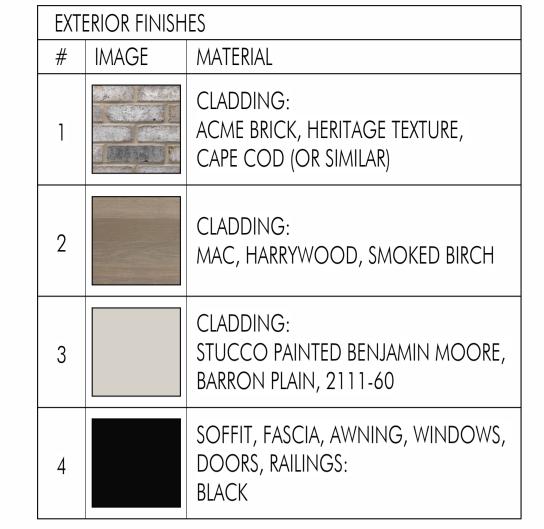

**Revision No., Date** and Description

07.28.23 SCHEMATIC PLANS 10.03.23 90% DP REVIEW 11.17.23 FOR REVIEW 12.13.23 FOR REVIEW 12.18.23 FOR REVIEW

PHONE:250-448-7801

205-1626 Richter Street, Kelowna, BC V1Y 2M3

www.limearchitecture.com

All ideas, designs, drawings and specifications are the exclusive property of

expressed written consent of LIME Architecture Inc. All Contracting Trades

discrepancies are to be reported

immediately to LIME Architecture Inc. Do

All trades are to execute the work in

not Scale any dimensions from this drawing.

accordance with the current municipality building by-laws and requirements of other local authorities having jurisdiction as well as the british columbia building code -

(most recent edition) including all published revisions and addenda. All trades shall

assume full responsiblity for the locations and protection of all under and above

ground utilities, wires and conduit connections, including (but not limited to) water, sewer, gas, hydro and telephone.

LIME Architecture Inc. As instruments of service, they may not be used or reproduced in any manner without the

shall check and verify all levels, dimensions, data and conditions on the site prior to commencement of any work. Any

COPYRIGHT. ALL RIGHTS RESERVED


12.19.23 FOR DP


**Plot Date** 12.19.23

PROJECT 2654 GORE STREET

DRAWING TITLE

FRONT ELEVATIONS

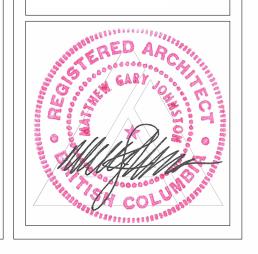

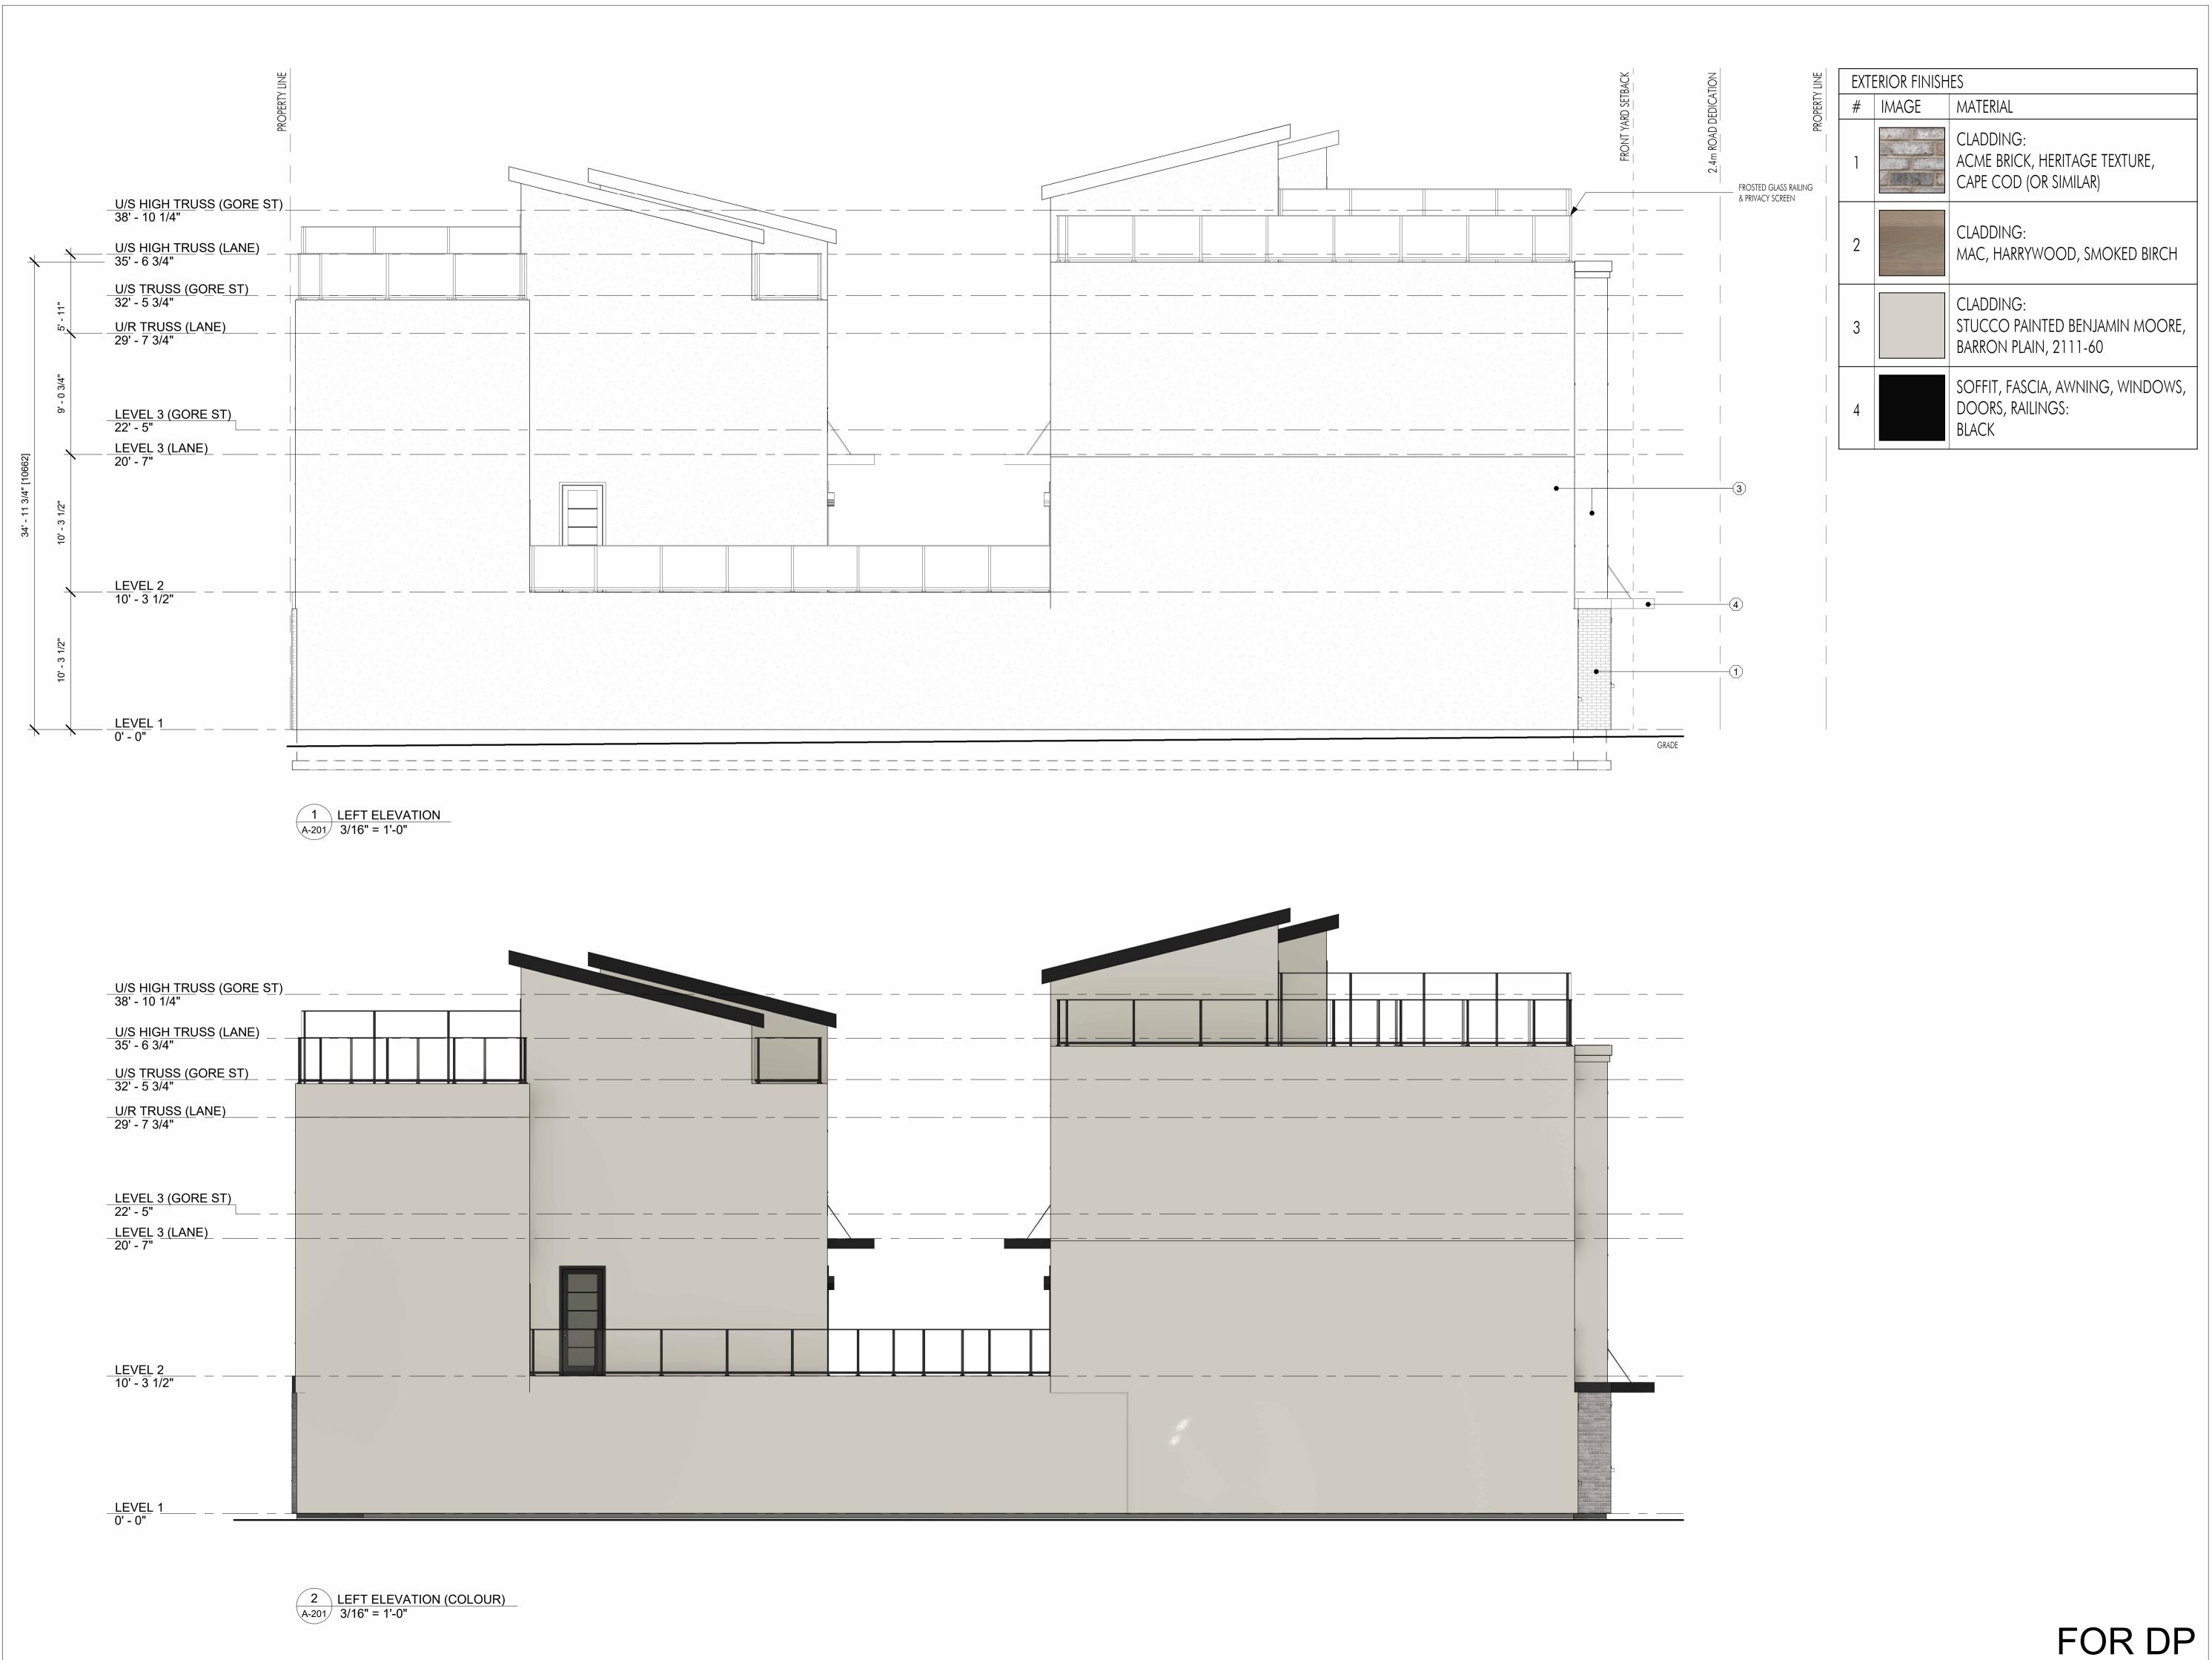

205-1626 Richter Street, Kelowna, BC V1Y 2M3 www.limearchitecture.com

COPYRIGHT. ALL RIGHTS RESERVED

All ideas, designs, drawings and specifications are the exclusive property of LIME Architecture Inc. As instruments of service, they may not be used or reproduced in any manner without the expressed written consent of LIME Architecture Inc. All Contracting Trades shall check and verify all levels, dimensions, data and conditions on the site prior to commencement of any work. Any discrepancies are to be reported immediately to LIME Architecture Inc. Do

All trades are to execute the work in accordance with the current municipality building by-laws and requirements of other local authorities having jurisdiction as well as the british columbia building code -(most recent edition) including all published revisions and addenda. All trades shall assume full responsiblity for the locations and protection of all under and above ground utilities, wires and conduit connections, including (but not limited to) water, sewer, gas, hydro and telephone.

not Scale any dimensions from this drawing.

**Revision No., Date** and Description

10.03.23 90% DP REVIEW 11.17.23 FOR REVIEW

12.13.23 FOR REVIEW 12.18.23 FOR REVIEW

12.19.23 FOR DP


PROJECT 2654 GORE STREET

Plot Date 12.19.23


DRAWING TITLE

LEFT

ELEVATIONS

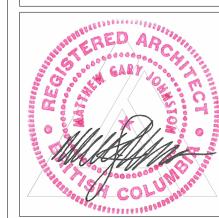



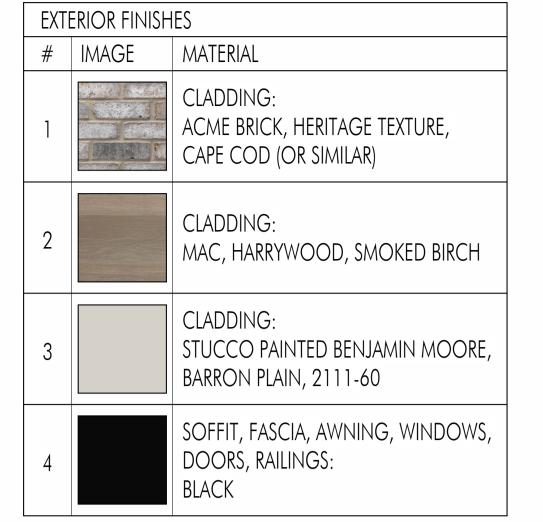

and Description 10.03.23 90% DP REVIEW 11.17.23 FOR REVIEW 12.13.23 FOR REVIEW

**Revision No., Date** 

PHONE:250-448-7801

205-1626 Richter Street, Kelowna, BC V1Y 2M3

www.limearchitecture.com

COPYRIGHT.
ALL RIGHTS RESERVED

All ideas, designs, drawings and specifications are the exclusive property of LIME Architecture Inc. As instruments of service, they may not be used or reproduced in any manner without the

expressed written consent of LIME

Architecture Inc. All Contracting Trades

shall check and verify all levels, dimensions, data and conditions on the site prior to commencement of any work. Any discrepancies are to be reported immediately to LIME Architecture Inc. Do

not Scale any dimensions from this drawing.

accordance with the current municipality building by-laws and requirements of other local authorities having jurisdiction as well as the british columbia building code -

(most recent edition) including all published revisions and addenda. All trades shall

assume full responsiblity for the locations and protection of all under and above

ground utilities, wires and conduit connections, including (but not limited to) water, sewer, gas, hydro and telephone.

All trades are to execute the work in

12.18.23 FOR REVIEW


12.19.23 FOR DP


**Plot Date** 12.19.23

PROJECT 2654 GORE STREET

DRAWING TITLE

BACK ELEVATIONS

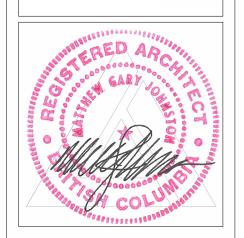

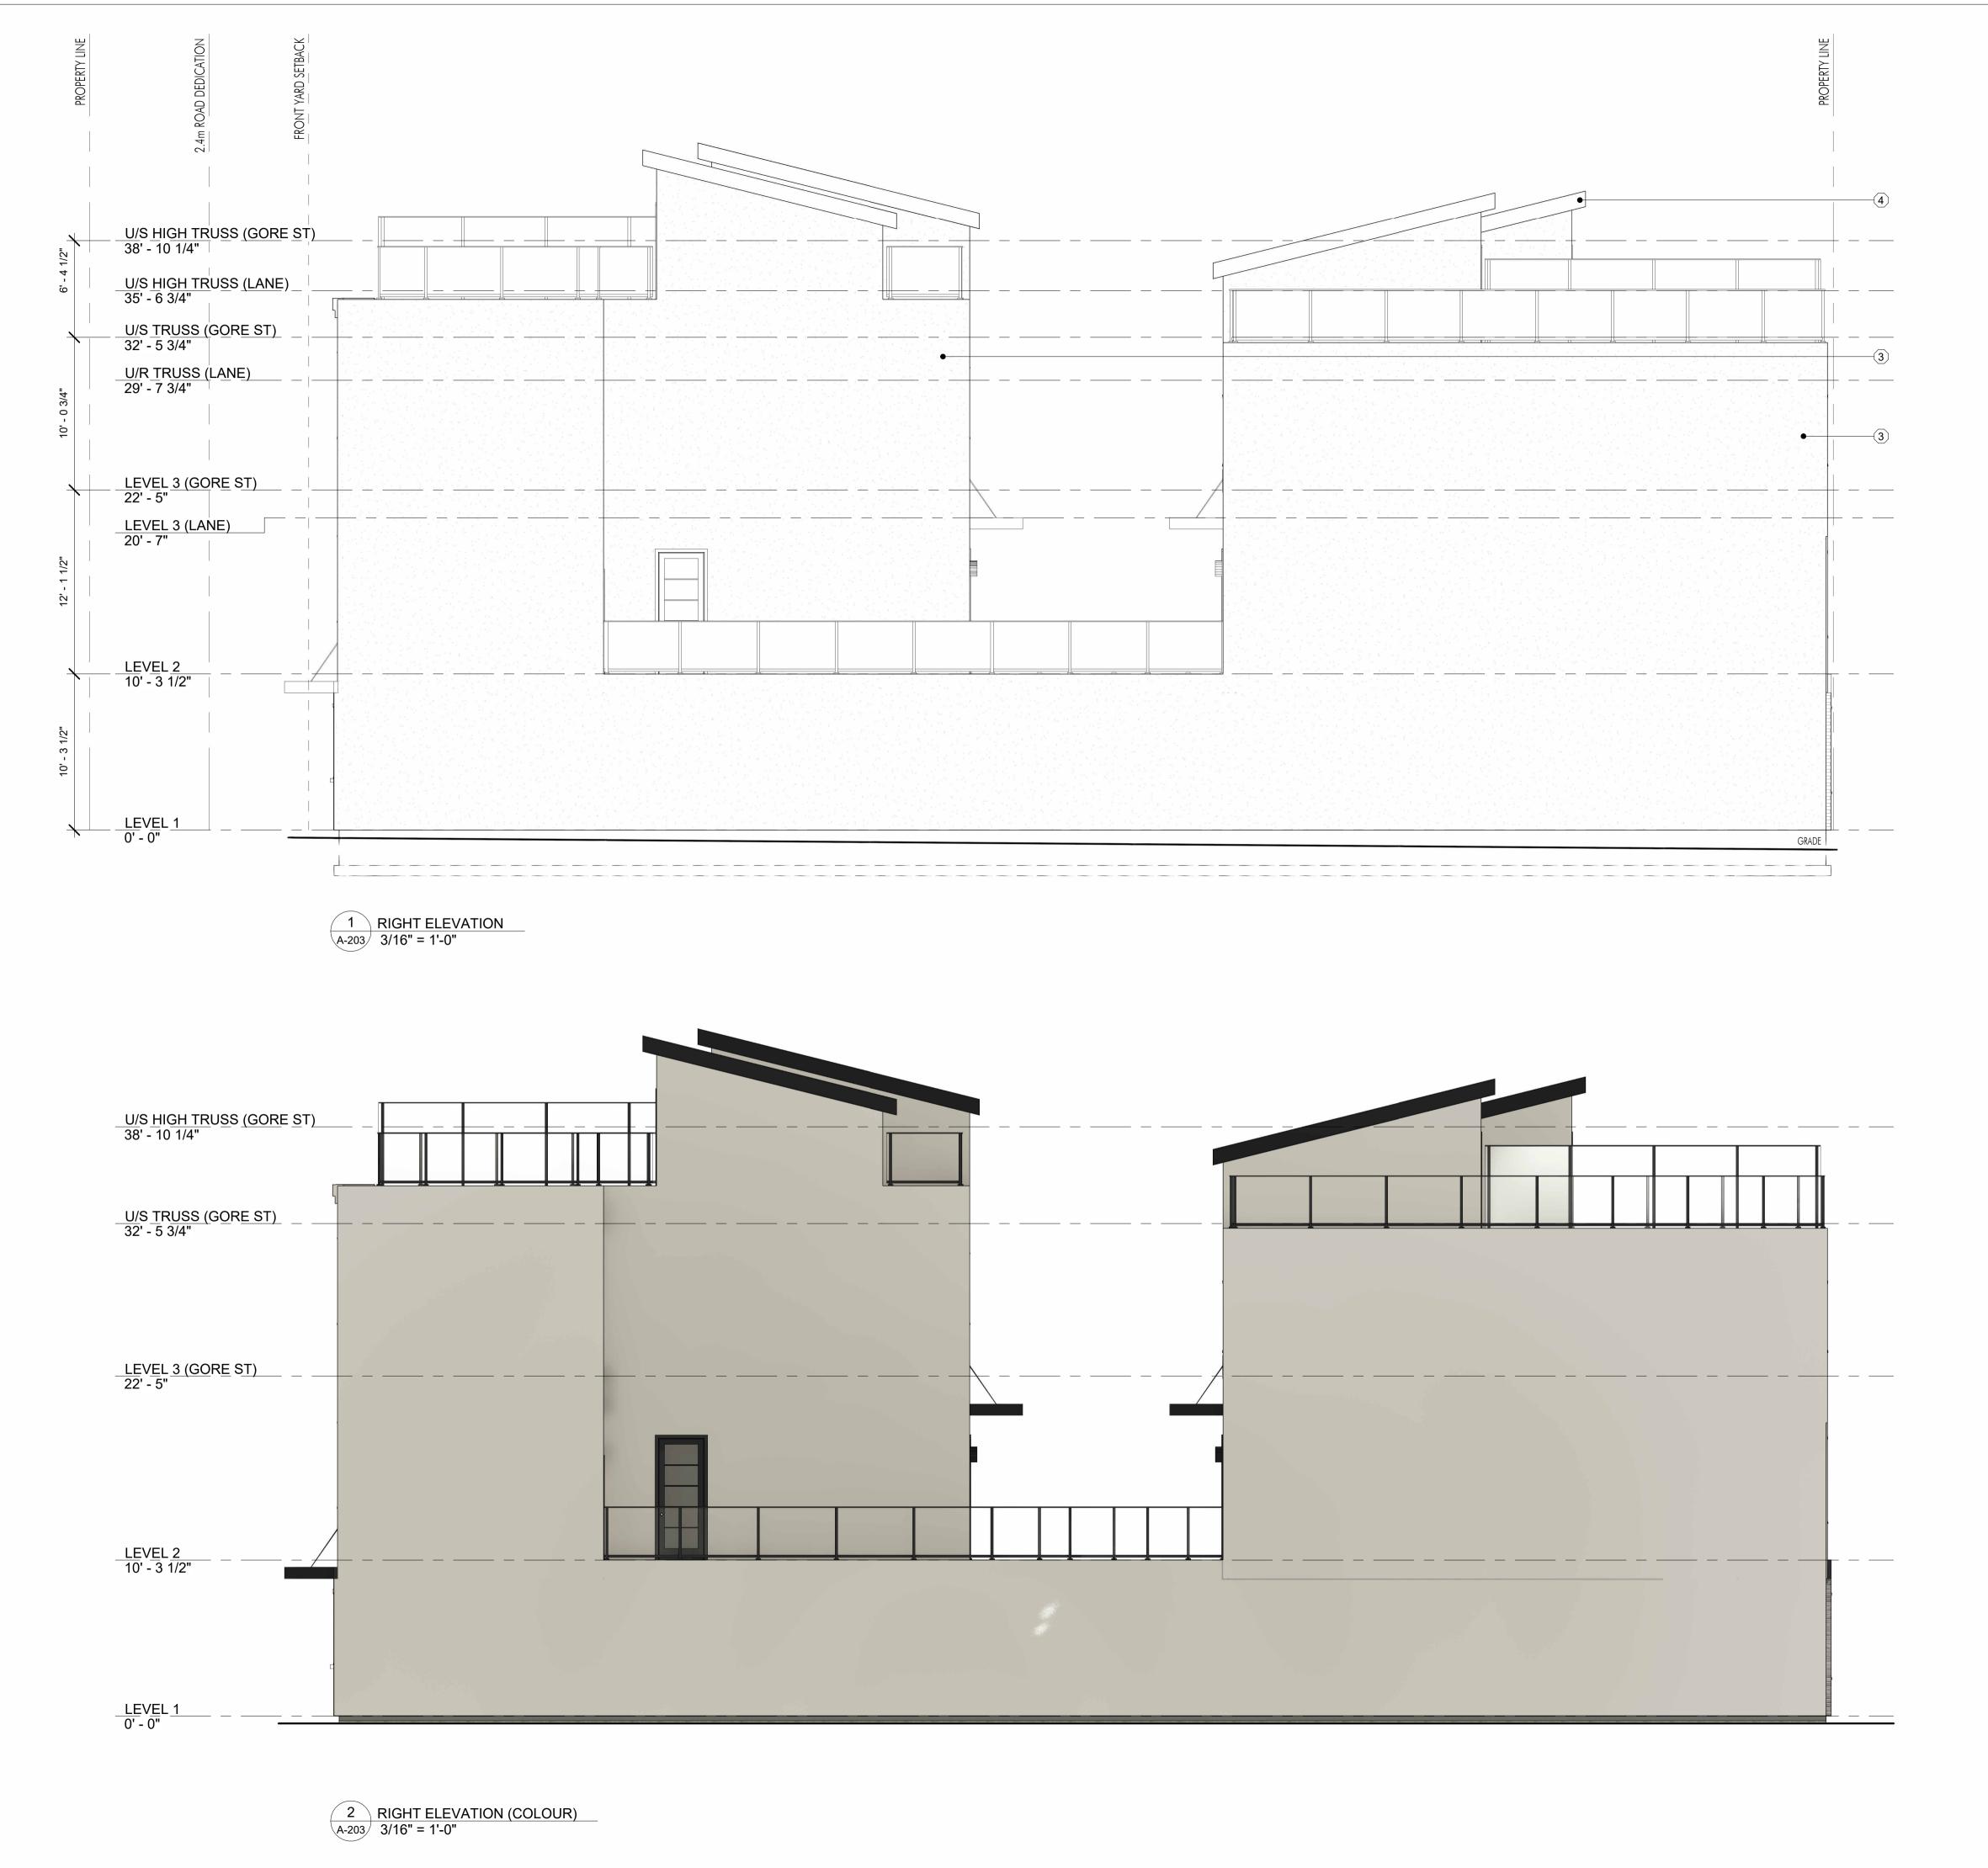

EXTERIOR FINISHES # IMAGE MATERIAL CLADDING: ACME BRICK, HERITAGE TEXTURE, CAPE COD (OR SIMILAR) CLADDING: MAC, HARRYWOOD, SMOKED BIRCH CLADDING: STUCCO PAINTED BENJAMIN MOORE, BARRON PLAIN, 2111-60 SOFFIT, FASCIA, AWNING, WINDOWS, DOORS, RAILINGS:
BLACK

PHONE:250-448-7801

205-1626 Richter Street, Kelowna, BC V1Y 2M3

COPYRIGHT. ALL RIGHTS RESERVED

All ideas, designs, drawings and specifications are the exclusive property of LIME Architecture Inc. As instruments of service, they may not be used or reproduced in any manner without the expressed written consent of LIME Architecture Inc. All Contracting Trades shall check and verify all levels, dimensions, data and conditions on the site prior to commencement of any work. Any discrepancies are to be reported immediately to LIME Architecture Inc. Do not Scale any dimensions from this drawing.

All trades are to execute the work in accordance with the current municipality building by-laws and requirements of other local authorities having jurisdiction as well as the british columbia building code -(most recent edition) including all published revisions and addenda. All trades shall assume full responsiblity for the locations and protection of all under and above ground utilities, wires and conduit connections, including (but not limited to) water, sewer, gas, hydro and telephone.

Revision No., Date and Description

10.03.23 90% DP REVIEW

11.17.23 FOR REVIEW 12.13.23 FOR REVIEW


12.18.23 FOR REVIEW


12.19.23 FOR DP

**Plot Date** 12.19.23 PROJECT

2654 GORE STREET DRAWING TITLE

RIGHT ELEVATIONS

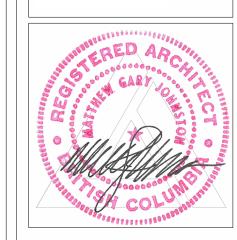


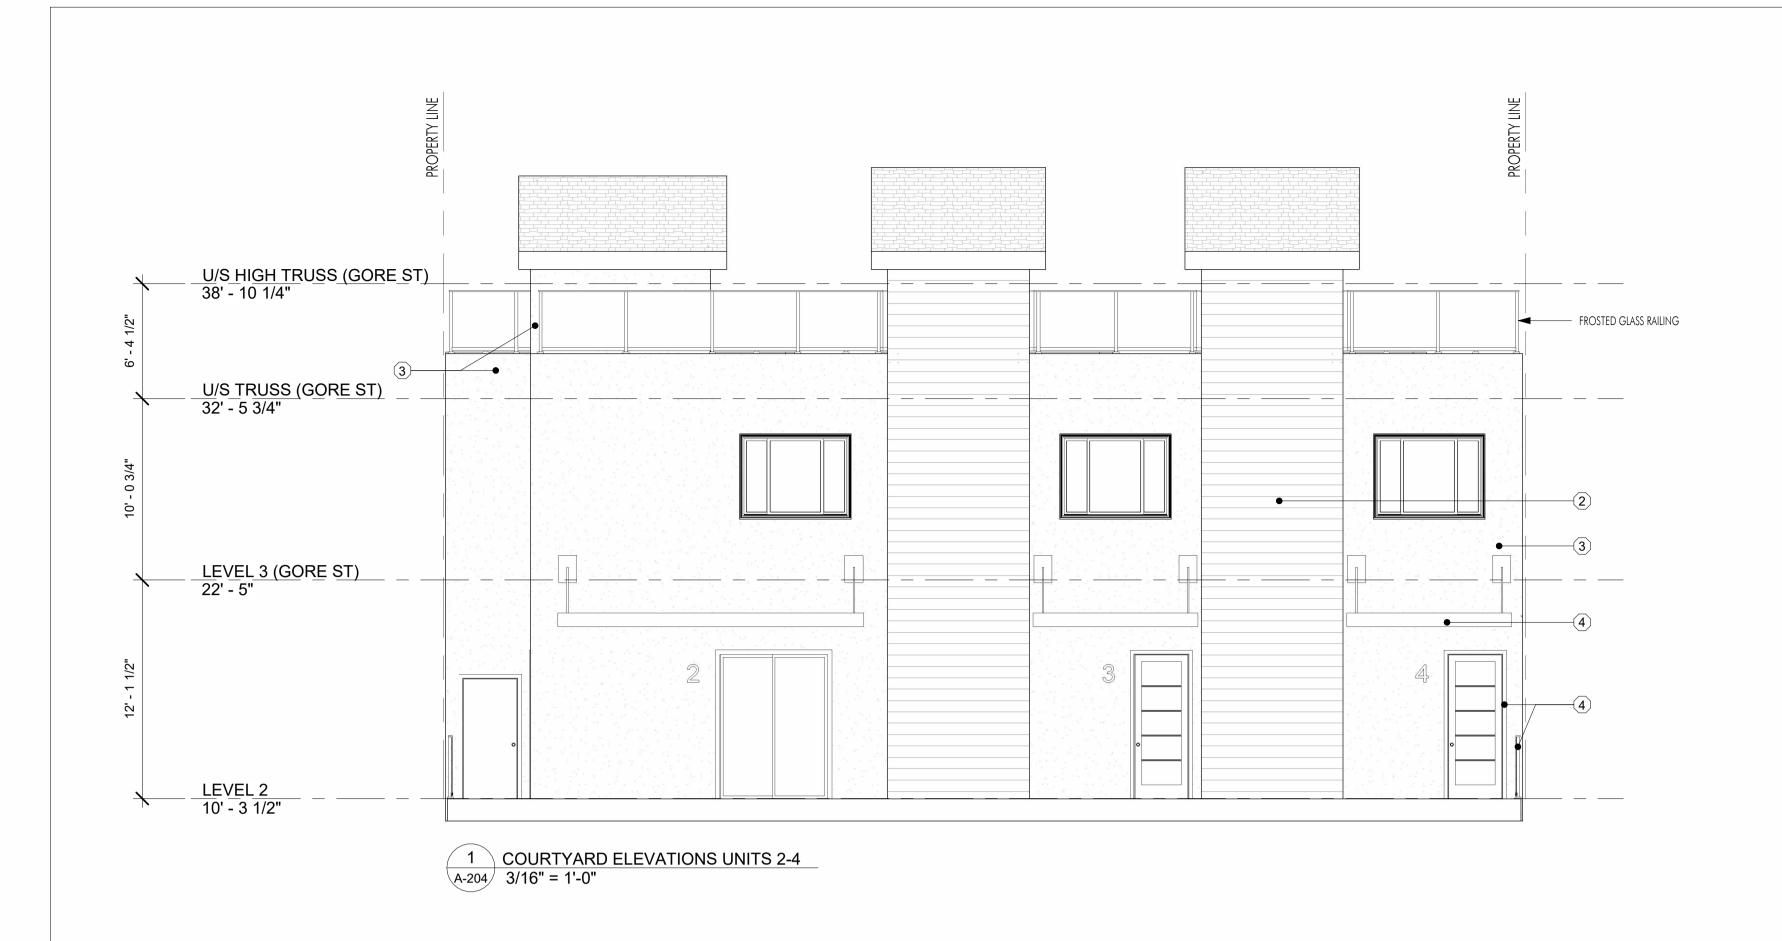



2 COURTYARD ELEVATIONS UNITS 2-4 (COLOUR)

A-204 3/16" = 1'-0"

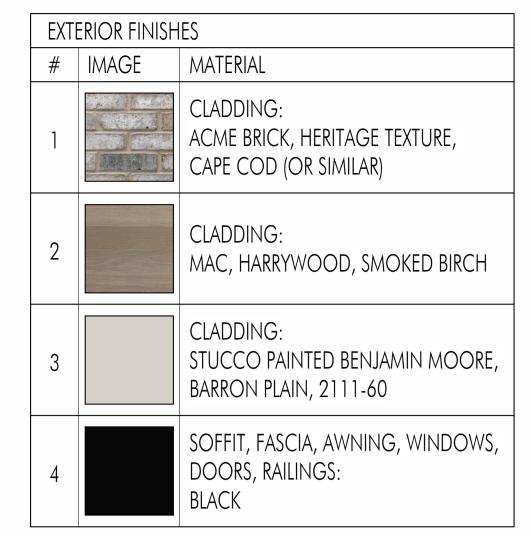

and Description

PHONE:250-448-7801

205-1626 Richter Street, Kelowna, BC V1Y 2M3

www.limearchitecture.com

All ideas, designs, drawings and specifications are the exclusive property of

expressed written consent of LIME

discrepancies are to be reported immediately to LIME Architecture Inc. Do

LIME Architecture Inc. As instruments of service, they may not be used or reproduced in any manner without the

Architecture Inc. All Contracting Trades

shall check and verify all levels, dimensions, data and conditions on the site prior to commencement of any work. Any

not Scale any dimensions from this drawing.

accordance with the current municipality building by-laws and requirements of other local authorities having jurisdiction as well as the british columbia building code -

(most recent edition) including all published revisions and addenda. All trades shall

assume full responsiblity for the locations and protection of all under and above

ground utilities, wires and conduit connections, including (but not limited to) water, sewer, gas, hydro and telephone.

All trades are to execute the work in

COPYRIGHT. ALL RIGHTS RESERVED

10.03.23 90% DP REVIEW 11.17.23 FOR REVIEW

**Revision No., Date** 

12.13.23 FOR REVIEW 12.18.23 FOR REVIEW


12.19.23 FOR DP

Plot Date 12.19.23 PROJECT

2654 GORE STREET

DRAWING TITLE

COURTYARD ELEVATIONS

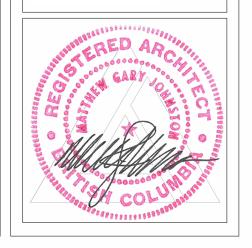








2 COURTYARD ELEVATIONS UNITS 5-7 (COLOUR)

A-205 3/16" = 1'-0"

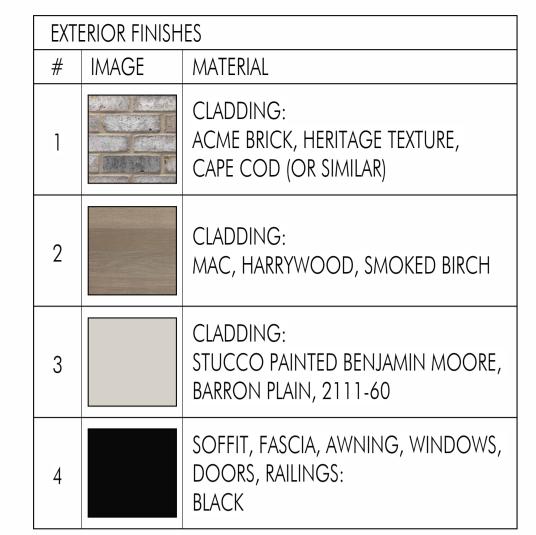

**Revision No., Date** and Description

PHONE:250-448-7801

205-1626 Richter Street, Kelowna, BC V1Y 2M3

www.limearchitecture.com

All ideas, designs, drawings and specifications are the exclusive property of LIME Architecture Inc. As instruments of service, they may not be used or reproduced in any manner without the

expressed written consent of LIME

commencement of any work. Any discrepancies are to be reported immediately to LIME Architecture Inc. Do

All trades are to execute the work in

Architecture Inc. All Contracting Trades

shall check and verify all levels, dimensions, data and conditions on the site prior to

not Scale any dimensions from this drawing.

accordance with the current municipality building by-laws and requirements of other local authorities having jurisdiction as well as the british columbia building code -

(most recent edition) including all published revisions and addenda. All trades shall

assume full responsiblity for the locations and protection of all under and above

ground utilities, wires and conduit connections, including (but not limited to) water, sewer, gas, hydro and telephone.

COPYRIGHT. ALL RIGHTS RESERVED

10.03.23 90% DP REVIEW 11.17.23 FOR REVIEW 12.13.23 FOR REVIEW

12.18.23 FOR REVIEW 12.19.23 FOR DP

Plot Date 12.19.23 PROJECT

2654 GORE STREET

DRAWING TITLE

COURTYARD ELEVATIONS



5 10 15 20 25 M





2654 GORE STREET -

Kelowna, BC

LEVEL 1

CONCEPTUAL

LANDSCAPE PLAN

ISSL	JED FOR / REVISION	
1	23.10.26	Development Permit
2	23.12.19	Development Permit
3		
4		
5		

PROJECT NO	23-0703
DESIGN BY	PH
DRAWN BY	PH
CHECKED BY	FB
DATE	DEC. 19, 2023
SCALE	1:75
PAGE SIZE	24x36

SEA

LANDSCAPE INFORMAION

TOTAL HARDSCAPING AREA: 39.2/640.0 = 6.13%

640.0 SQ.M 39.2 SQ.M

Site area: Hardscaping area:

1. PLANT MATERIAL AND CONSTRUCTION METHODS SHALL MEET OR EXCEED

CANDAIAN LANDSCAPE STANDARDS. ALL OFFSITE LANDSCAPE WORKS TO MEET CITY

2. ALL SOFT LANDSCAPE AREAS SHALL BE WATERED BY A FULLY AUTOMATIC TIMED

3. TREE AND SHRUB BEDS TO BE DRESSED IN A MINIMUM 75mm NATURAL WOOD MULCH AS SHOWN IN PLANS. DO NOT PLACE WEED MAT UNDERNEATH TREE AND

4. SHRUB BEDS TO RECEIVE A MINIMUM 300mm DEPTH TOPSOIL PLACEMENT. TREE

5. TURF AREA FROM SOD SHALL BE NO.1 GRADE GROWN FROM CERTIFIED SEED OF

IMPROVED CULTIVARS REGISTERED FOR SALE IN B.C. AND SHALL BE TOLERANT OF

DROUGHT CONDITIONS. A MINIMUM OF 150mm DEPTH OF GROWING MEDIUM IS REQUIRED BENEATH TURF AREAS. TURF AREAS SHALL MEET EXISTING GRADES AND

6. SITE GRADING AND DRAINAGE WILL ENSURE THAT ALL STRUCTURES HAVE POSITIVE

DRAINAGE AND THAT NO WATER OR LOOSE IMPEDIMENTS WILL BE DISCHARGED FROM THE LOT ONTO ADJACENT PUBLIC, COMMON, OR PRIVATE PROPERTIES.

7. FOR CONFORMANCE WITH DEVELOPMENT PERMIT LANDSCAPE REQUIREMENTS,

AND UTILITIES SHALL ENSURE THAT ALL BUILDING PERMIT SUBMITTALS ARE

COORDINATED WITH LANDSCAPE ARCHITECTURAL SUBMITTALS.

THE PRIME CONTRACTOR AND/OR CONSULTANTS REPONSIBLE FOR SITE SERVICING

BEDS TO RECEIVE A MINIMUM 1000mm DEPTH TOPSOIL PLACEMENT.

**NOTES** 

SHRUB BEDS.

HARD SURFACES FLUSH.

OF KELOWNA BYLAW 12375 STANDARDS.


UNDERGROUND IRRIGATION SYSTEM.



drawing number

without permission.

NOT FOR CONSTRUCTION
Copyright Reserved. This drawing is the property of Ecora Engineering & Resource Group Ltd. and shall not be reproduced, resold, or tendered

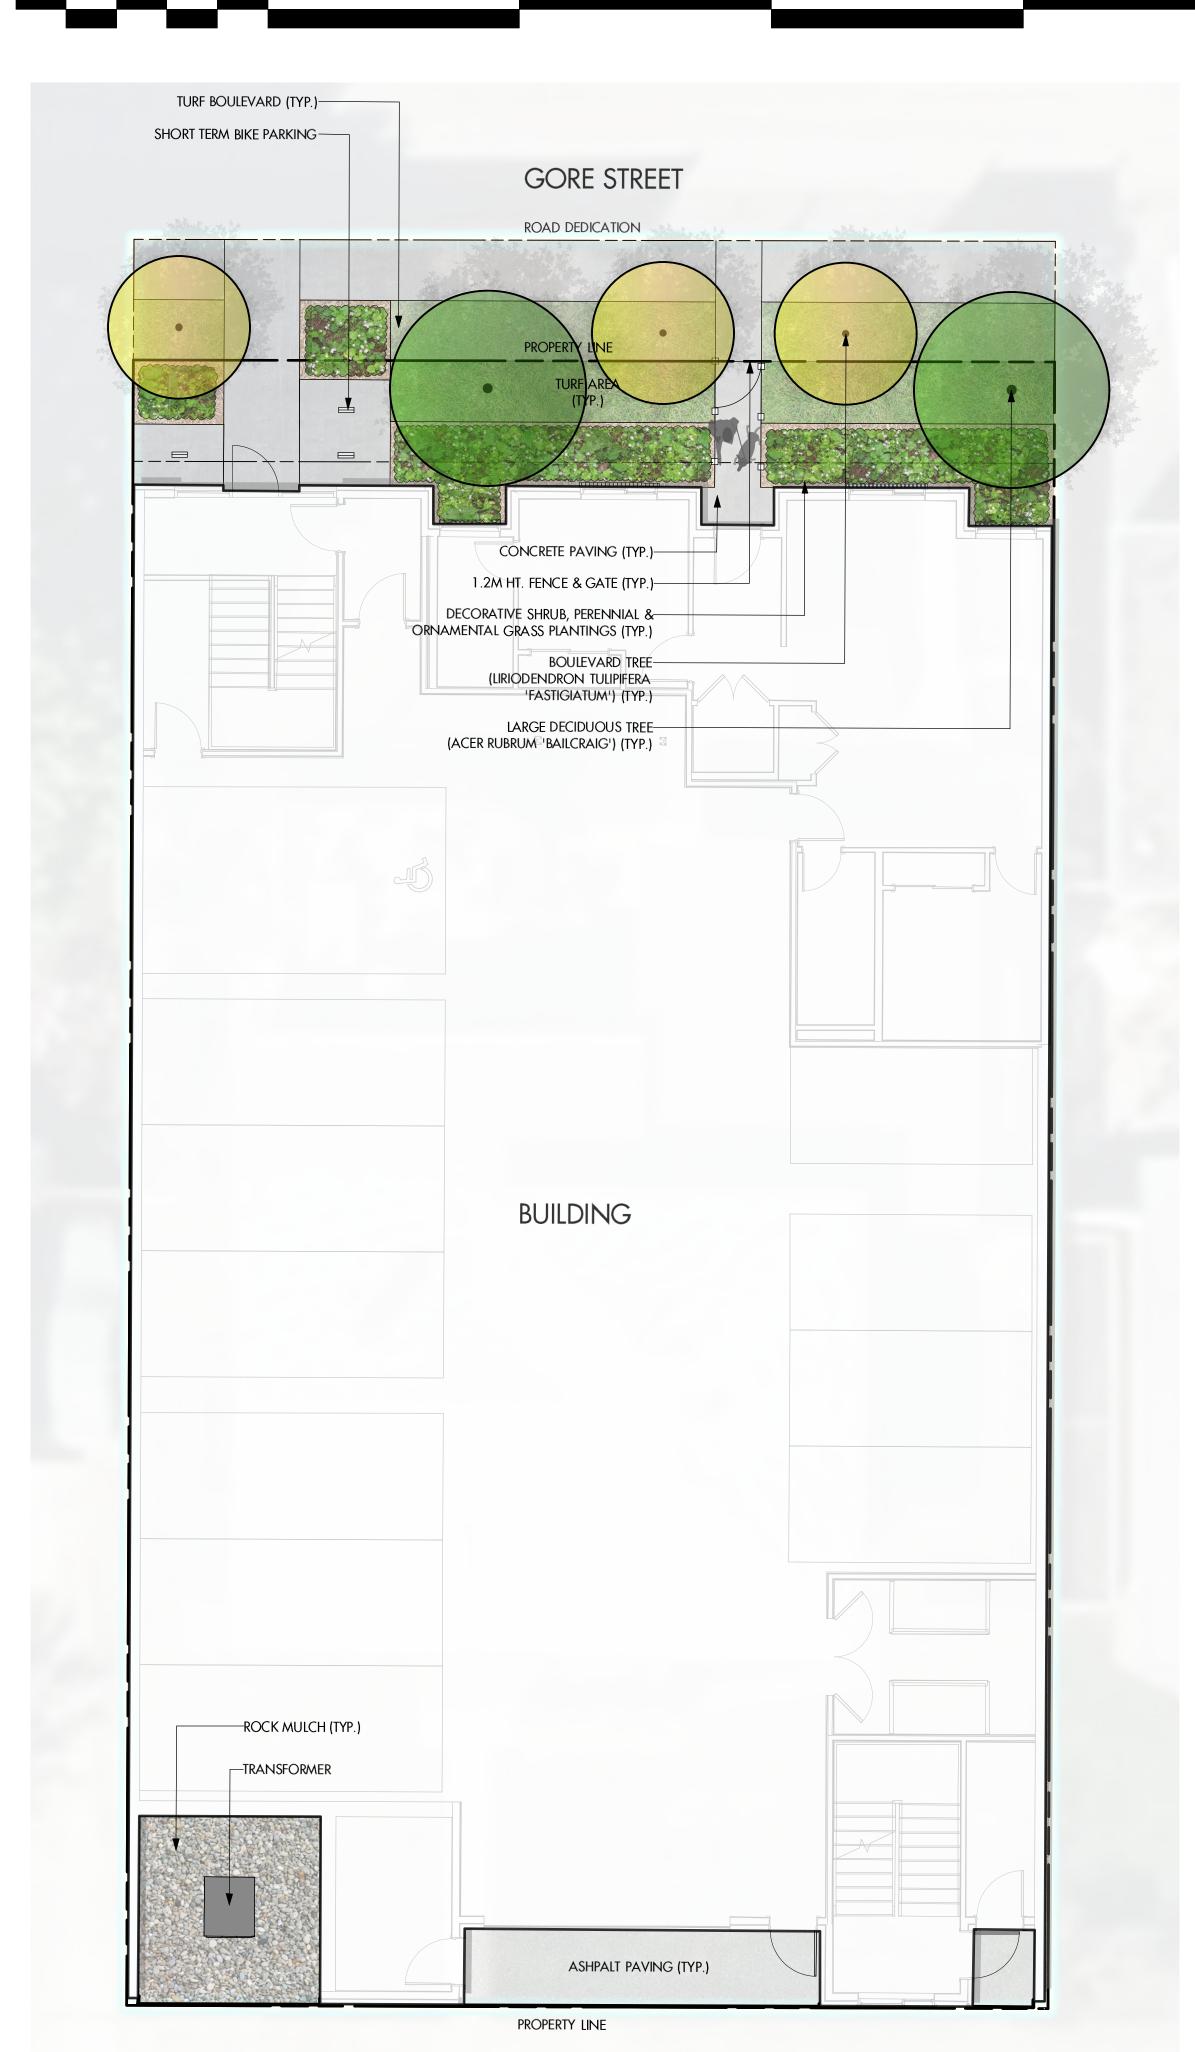

#### **PLANT LIST BOTANICAL NAME** QTY SIZE/SPACING & REMARKS COMMON NAME TREES ACER RUBRUM 'BAILCRAIG' SCARLET JEWEL RED MAPLE 2 5cm CAL. /PER PLAN LIRIODENDRON TULIPIFERA 'FASTIGIATUM' COLUMNAR TULIP TREE 3 5cm CAL. /PER PLAN SHRUBS ROSA WOODSII WOOD'S ROSE 2 #02 CONT. /1.5M O.C. SPACING SYMPHORICARPOS ALBUS WHITE SNOWBERRY 4 #02 CONT. /1.0M O.C. SPACING CORNUS SERICA 'RED OSIER' RED OSIER DOGWOOD 2 #02 CONT. /1.5M O.C. SPACING PERENNIALS & ORNAMENTAL GRASSES ECHINACEA PURPUREA 'ALBA' WHITE SWAN CONEFLOWER 4 #01 CONT. /0.6M O.C. SPACING HEMEROCALLIS 'PARDON ME' PARDON ME DAYLILY #01 CONT. /0.75M O.C. SPACING 4 #01 CONT. /0.6M O.C. SPACING LAVENDULA ANGUSTIFOLIA 'HIDCOTE SUPERIOR' HIDCOTE SUPERIOR LAVENDER PACHYSANDRA TERMINALIS JAPANESE PACHYSANDRA 18 #01 CONT. /0.3M O.C. SPACING RUDBECKIA FULGIDA 'GOLDSTURM' BLACK-EYED SUSAN 6 #01 CONT. /0.5M O.C. SPACING

5 10 15 20 25 M





PLANT LIST			
BOTANICAL NAME	COMMON NAME	QTY	SIZE/SPACING & REMARKS
SHRUBS			
POTENTILLA FRUTICOSA 'ABBOTSWOOD'	ABBOTTSWOOD POTENTILLA	13	#02 CONT. /0.9M O.C. SPACING
PERENNIALS & ORNAMENTAL GRASSES			
ASTILBE X ARENDSII 'DEUTSCHLAND'	DEUTSCHLAND ASTILBE	7	#01 CONT. /0.5M O.C. SPACING
BERGENIA CORDIFOLIA	HEARTLEAF BERGENIA	7	#01 CONT. /0.5M O.C. SPACING
PACHYSANDRA TERMINALIS	JAPANESE SPURGE	19	#01 CONT. /0.3M O.C. SPACING
SEDUM 'HERBSTFREUDE'	AUTUMN JOY STONECROP	7	#01 CONT. /0.5M O.C. SPACING

### **NOTES**

1. Plant material and construction methods shall meet or exceed candaian landscape standards. All offsite landscape works to meet city of kelowna bylaw 12375 standards.

2. ALL SOFT LANDSCAPE AREAS SHALL BE WATERED BY A FULLY AUTOMATIC TIMED UNDERGROUND IRRIGATION SYSTEM.

3. TREE AND SHRUB BEDS TO BE DRESSED IN A MINIMUM 75mm NATURAL WOOD MULCH AS SHOWN IN PLANS. DO NOT PLACE WEED MAT UNDERNEATH TREE AND SHRUB BEDS.

4. SHRUB BEDS TO RECEIVE A MINIMUM 300mm DEPTH TOPSOIL PLACEMENT. TREE BEDS TO RECEIVE A

4. SHRUB BEDS TO RECEIVE A MINIMUM 300mm DEPTH TOPSOIL PLACEMENT. TREE BEDS TO RECEIVE A MINIMUM 1000mm DEPTH TOPSOIL PLACEMENT.

5. TURF AREA FROM SOD SHALL BE NO.1 GRADE GROWN FROM CERTIFIED SEED OF IMPROVED CULTIVARS REGISTERED FOR SALE IN B.C. AND SHALL BE TOLERANT OF DROUGHT CONDITIONS. A MINIMUM OF 150mm DEPTH OF GROWING MEDIUM IS REQUIRED BENEATH TURF AREAS. TURF AREAS SHALL MEET EXISTING GRADES AND HARD SURFACES FLUSH.

6. SITE GRADING AND DRAINAGE WILL ENSURE THAT ALL STRUCTURES HAVE POSITIVE DRAINAGE AND THAT NO WATER OR LOOSE IMPEDIMENTS WILL BE DISCHARGED FROM THE LOT ONTO ADJACENT PUBLIC, COMMON, OR PRIVATE PROPERTIES.

7. FOR CONFORMANCE WITH DEVELOPMENT PERMIT LANDSCAPE REQUIREMENTS, THE PRIME CONTRACTOR AND/OR CONSULTANTS REPONSIBLE FOR SITE SERVICING AND UTILITIES SHALL ENSURE THAT ALL BUILDING PERMIT SUBMITTALS ARE COORDINATED WITH LANDSCAPE ARCHITECTURAL SUBMITTALS.



PROJECT TITLE

# 2654 GORE STREET -LEVEL 2

Kelowna, BC

drawing title

# CONCEPTUAL LANDSCAPE PLAN

issued for / revision

3	
4	
5	

PROJECT NO	23-0703
DESIGN BY	PH
DRAVVN BY	JN
CHECKED BY	FB
DATE	DEC. 19, 2023
SCALE	1:75
PAGE SIZE	24x36

SEAL



drawing number

without permission.


L 2 / 4

NOT FOR CONSTRUCTION
Copyright Reserved. This drawing is the property of Ecora Engineering &

Resource Group Ltd. and shall not be reproduced, resold, or tendered

25 M

### **GORE STREET**

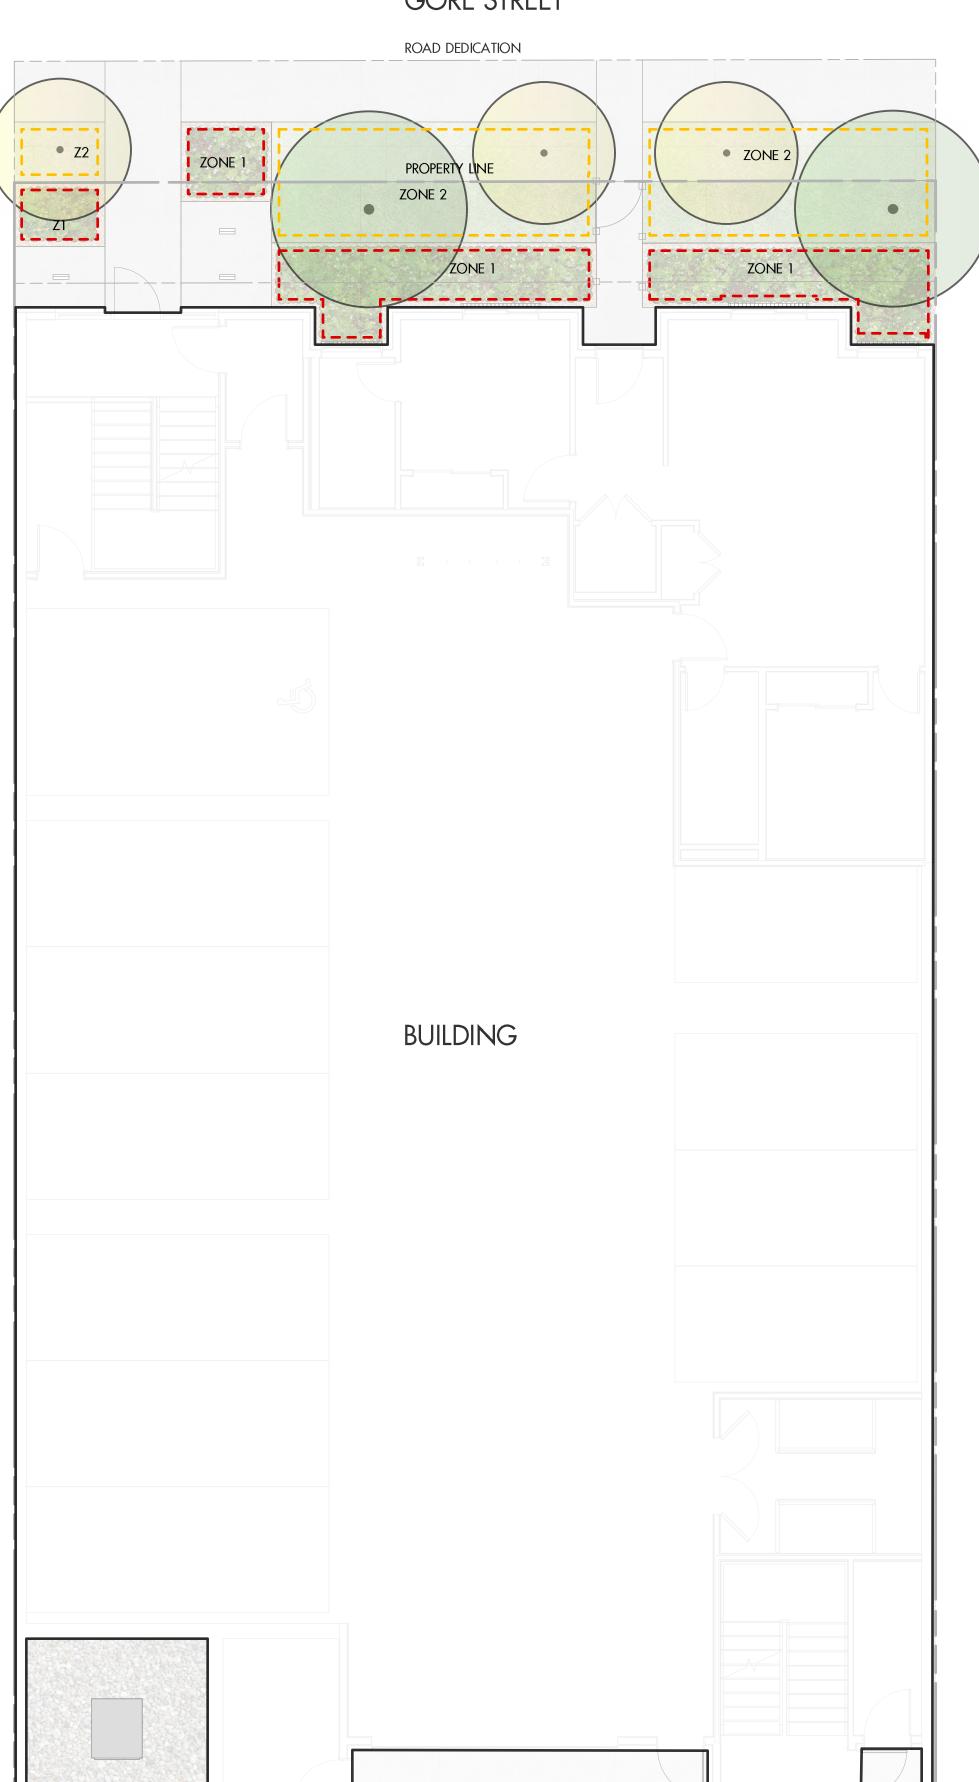

PROPERTY LINE

## **IRRIGATION LEGEND**

1----

ZONE #1: HIGH EFFICIENCY SUBSURFACE DRIP IRRIGATION FOR MODERATE WATER USE PLANTING AREAS r---1 TOTAL AREA: 25 sq.m.

ZONE #2: LOW VOLUME POP-UP SPRAYHEADS FOR TURF AREAS TOTAL AREA: 32 sq.m. MICROCLIMATE: NORTHWEST EXPOSURE, PARTIALLY SHADED BY TREES ESTIMATED ANNUAL WATER USE: 27 cu.m.

ZONE #3: HIGH EFFICIENCY SUBSURFACE DRIP IRRIGATION FOR MODERATE WATER USE PLANTING AREAS

r---1 TOTAL AREA: 17 sq.m.



www.ecora.ca



PROJECT TITLE

# 2654 GORE STREET -LEVEL 1

Kelowna, BC

DRAWING TITLE

# WATER CONSERVATION / IRRIGATION PLAN

ISSL	jed for / revision	
1	23.10.26	Development Permit
2	23.12.19	Development Permit
3		
4		
5		

PROJECT NO	23-0/03
design by	PH
DRAWN BY	PH
CHECKED BY	FB
DATE	DEC. 19, 2023
SCALE	1:75
PAGE SIZE	24x36

WATER CONSERVATION CALCULATIONS

\*REFER ATTACHED IRRIGATION APPLICATION FOR DETAILED CALCULATIONS

1. IRRIGATION PRODUCTS AND INSTALLATION METHODS SHALL MEET OR EXCEED THE

SPECIFICATIONS IN THE CITY OF KELOWNA BYLAW 7900 (PART 6, SCHEDULE 5).

REQUIREMENTS OF THE WATER USE REGULATION BYLAW NO. 10480 AND THE SUPPLEMENTARY

2. THE IRRIGATION SYSTEM SHALL MEET THE REQUIREMENTS, REGULATIONS, AND BYLAWS OF THE

DEVICE, WATER METER, AND SHUT OFF VALVE LOCATED OUTSIDE THE BUILDING ACCESSIBLE TO THE

4. AN APPROVED SMART CONTROLLER SHALL BE INSTALLED. THE IRRIGATION SCHEDULING TIMES

6. IRRIGATION SLEEVES SHALL BE INSTALLED TO ROUTE IRRIGATION LINES UNDER HARD SURFACES

SHALL UTILIZE A MAXIMUM ET VALUE OF 7" / MONTH (KELOWNA JULY ET), TAKING INTO

5. DRIP LINE AND EMITTERS SHALL INCORPORATE TECHNOLOGY TO LIMIT ROOT INTRUSION.

7. IRRIGATION PIPE SHALL BE SIZED TO ALLOW FOR A MAXIMUM FLOW OF 1.5m /SEC.

8. A FLOW SENSOR AND MASTER VALVE SHALL BE CONNECTED TO THE CONTROLLER AND

PROGRAMMED TO STOP FLOW TO THE SYSTEM IN CASE OF AN IRRIGATION WATER LEAK.

3. THE IRRIGATION SYSTEM SHALL BE EQUIPPED WITH AN APPROVED BACKFLOW PREVENTION

LANDSCAPE MAXIMUM WATER BUDGET (WB) = 52 cu.m. / year

ESTIMATED LANDSCAPE WATER USE (WU) = 41 cu.m. / year

CONSIDERATION SOIL TYPE, SLOPE, AND MICROCLIMATE.

WATER BALANCE = 11 cu.m. / year

**IRRIGATION NOTES** 

WATER PURVEYOR.




drawing number

without permission.

**NOT FOR CONSTRUCTION** Copyright Reserved. This drawing is the property of Ecora Engineering & Resource Group Ltd. and shall not be reproduced, resold, or tendered

MICROCLIMATE: NORTHWEST EXPOSURE, PARTIALLY SHADED BY BUILDING & TREES ESTIMATED ANNUAL WATER USE: 8 cu.m.

MICROCLIMATE: SOUTH EXPOSURE, PARTIALLY SHADED BY BUILDING ESTIMATED ANNUAL WATER USE: 6 cu.m.

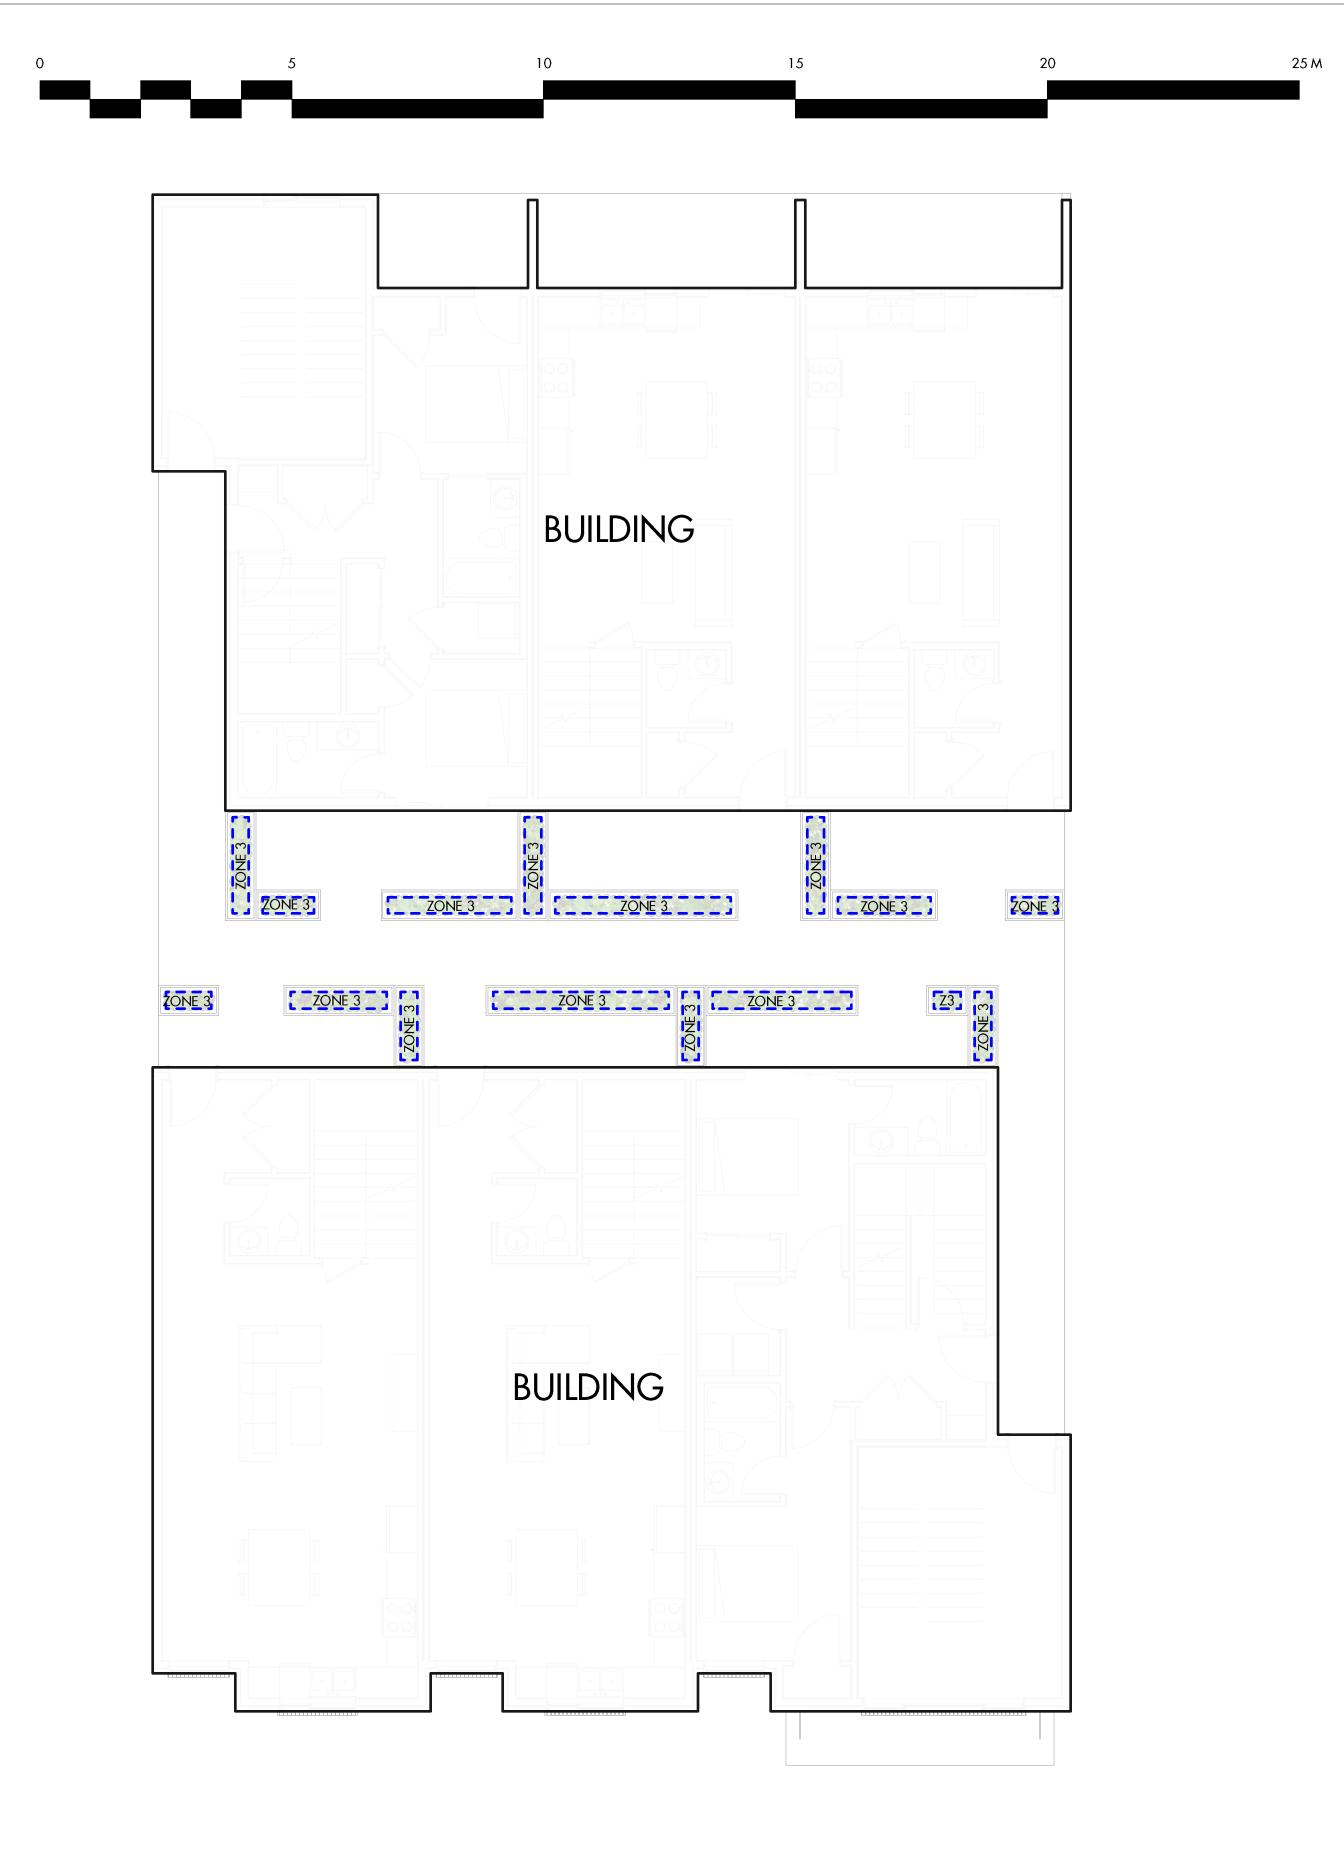





# 2654 GORE STREET -LEVEL 2

Kelowna, BC

DRAWING TITLE

# WATER CONSERVATION / IRRIGATION PLAN

1	23.10.26	Development Permit
2	23.12.19	Development Permit
3		
4		
5		

PROJECT NO	23-0703	
DESIGN BY	PH	
DRAVVN BY	JN	
CHECKED BY	FB	
DATE	DEC. 19, 2023	
SCALE	1:75	
DACE CIZE	0.4006	



drawing number

without permission.

NOT FOR CONSTRUCTION Copyright Reserved. This drawing is the property of Ecora Engineering & Resource Group Ltd. and shall not be reproduced, resold, or tendered

### WATER CONSERVATION CALCULATIONS

LANDSCAPE MAXIMUM WATER BUDGET (WB) = 52 cu.m. / year ESTIMATED LANDSCAPE WATER USE (WU) = 41 cu.m. / year WATER BALANCE = 11 cu.m. / year

**IRRIGATION NOTES** 

WATER PURVEYOR.

\*REFER ATTACHED IRRIGATION APPLICATION FOR DETAILED CALCULATIONS

1. IRRIGATION PRODUCTS AND INSTALLATION METHODS SHALL MEET OR EXCEED THE

SPECIFICATIONS IN THE CITY OF KELOWNA BYLAW 7900 (PART 6, SCHEDULE 5).

REQUIREMENTS OF THE WATER USE REGULATION BYLAW NO. 10480 AND THE SUPPLEMENTARY

2. THE IRRIGATION SYSTEM SHALL MEET THE REQUIREMENTS, REGULATIONS, AND BYLAWS OF THE

DEVICE, WATER METER, AND SHUT OFF VALVE LOCATED OUTSIDE THE BUILDING ACCESSIBLE TO THE

4. AN APPROVED SMART CONTROLLER SHALL BE INSTALLED. THE IRRIGATION SCHEDULING TIMES

6. IRRIGATION SLEEVES SHALL BE INSTALLED TO ROUTE IRRIGATION LINES UNDER HARD SURFACES

SHALL UTILIZE A MAXIMUM ET VALUE OF 7" / MONTH (KELOWNA JULY ET), TAKING INTO

5. DRIP LINE AND EMITTERS SHALL INCORPORATE TECHNOLOGY TO LIMIT ROOT INTRUSION.

7. IRRIGATION PIPE SHALL BE SIZED TO ALLOW FOR A MAXIMUM FLOW OF 1.5m /SEC.

8. A FLOW SENSOR AND MASTER VALVE SHALL BE CONNECTED TO THE CONTROLLER AND

PROGRAMMED TO STOP FLOW TO THE SYSTEM IN CASE OF AN IRRIGATION WATER LEAK.

CONSIDERATION SOIL TYPE, SLOPE, AND MICROCLIMATE.

3. THE IRRIGATION SYSTEM SHALL BE EQUIPPED WITH AN APPROVED BACKFLOW PREVENTION

ZONE #1: HIGH EFFICIENCY SUBSURFACE DRIP IRRIGATION FOR MODERATE WATER USE PLANTING AREAS

TOTAL AREA: 25 sq.m. MICROCLIMATE: NORTHWEST EXPOSURE, PARTIALLY SHADED BY BUILDING & TREES ESTIMATED ANNUAL WATER USE: 8 cu.m.

ZONE #2: LOW VOLUME POP-UP SPRAYHEADS FOR TURF AREAS TOTAL AREA: 32 sq.m. MICROCLIMATE: NORTHWEST EXPOSURE, PARTIALLY SHADED BY TREES

**IRRIGATION LEGEND** 

r---1

1----

ZONE #3: HIGH EFFICIENCY SUBSURFACE DRIP IRRIGATION FOR MODERATE WATER USE PLANTING AREAS

r---1 TOTAL AREA: 17 sq.m. ESTIMATED ANNUAL WATER USE: 6 cu.m.

ESTIMATED ANNUAL WATER USE: 27 cu.m.

MICROCLIMATE: SOUTH EXPOSURE, PARTIALLY SHADED BY BUILDING